

Affidavit

Township of Puslinch 7404 Wellington County Rd 34, Puslinch, ON NOB 2J0 (519) 763-1226

Cloudpermit application number	•				
CA-3523001-P-2025-2					

Applicant, Property owner, P	ayer		
Last name Schram	First name Nadine		Corporation or partnership
Street address 19 Water St	Unit number		Lot / Con.
Municipality Puslinch	Postal code N0B2J0		Province Ontario
Other phone		Mobile phor	ne
Fax		Email	

Subject Land Information				
Address	Legal description	Roll number		
19 WATER ROAD PV (Primary)	PLAN 61M203 LOT 95	2301000006166150000		

Sworn Declaration of Applicant

Complete in the presence of a Commissioner for taking affidavits

I, Nadine Schram, solemnly declare that the information required under Schedule 1 to Ontario Regulation 545/06 and provided by the Applicant is accurate and that the information contained in the documents that accompany this application is accurate, and I make this solemn declaration conscientiously believing it to be true, and knowing that it is of the same force and effect as if made under oath and by virtue of the Canada Evidence Act.

Signature of Applicant (sign in the presence	e of a Commissioner for taking affidavits)	
Signature of Commissioner for taking /	Municipality	Day, month, year
affida /		
dilida	T) . (D)	T 0 2-05
	Township of Puslinch	1/10 9 2025
	1000000	OM (
Bi ' i formation below		
Place an imprint of your stamp below		

Monika Alyse Farncombe, a Commissioner, etc., Province of Ontario, for the Corporation of the Township of Puslinch. Expires February 14, 2027.

Affidavit and signatures

Applicant

The Nadine Schram, Applicant is required to agree to erect and maintain a sign on the subject lands and to permit Township employees/representatives to enter the lands for site visits. The sign will be provided to the applicant for posting on the property by Township planning staff along with instructions on how and where to post the sign. The sign must be posted at least 10 days prior to the Committee of Adjustment meeting date for the application and must remain on the property until the 20 day appeal period is expired.

Notice with respect to collection of personal information

Personal information on this form is collected under the authority of the Planning Act. The information is used for the purpose of processing this application and administering the legislation and is maintained in accordance with the Municipal Freedom of Information and Protection of Privacy Act. Questions regarding the collection of this information may be directed to the Township Clerk's office.

The Township of Puslinch is committed to providing accessible formats and communication supports for people with a disability. If another format would work better for you, please contact the Township Clerk's office for assistance.




Digitally signed on 2025-01-09, 4:13:17 p.m. EST by Nadine Schram.

Send correspondence to	1/36/11				
Send correspondence to					
Owner(s) Agent		Others			
Who to send the Invoice to					
Owner Agent		Other			
Provide a description of the "en	tire" prope	erty			
Concession		Lot		Registered	d Plan Number
Area in Hectares		Area in Acres		Depth in N	∕ leters
Depth in Feet	Frontage	in Meters	Frontage in Feet		Width of road allowance (if known)
Reason for Application	N III				
Please indicate the Section of the Planning Act under which this application is being made Section 45(1) relates to a change to a by-law standard (e.g. setbacks, frontage, height, etc.) Section 45(2) relates to a change to or expansion of an existing legal non- conforming use What is the nature and extent of the relief that is being applied for? Relief from reduced setback to detached garage of 0m from 0.6m Why is it not possible to comply with the provisions of the by-law? Existing concrete pad where previous sheds were built before ownership was taken over. Previous sheds have been removed and new shed placed on existing concrete pad.					evious sheds were built before ious sheds have been
What is the current Official Plan	and zonin	g status?			
Official Plan Designation N/A			Zoning Designation RUR (sp86)		
What is the access to the subject	t property?		If other please speci	fy	
Provincial Highway Continually Seasonally maintained maintained municipal road Other Continually Seasonally maintained municipal road Private Private					
What is the name of the road or the subject property? Wellington Rd 34 E	street that	provides access to	docking facilities use	ed or to be u	e describe the parking and used and the approximate the subject land to the nearest

Existing and Proposed Service					
Indicate the applicable water supply and	sewage disposal:				
Private Well			Existing	Proposed	
Communal Water			Existing	Proposed	
Provincial Water Taking Permit			Existing	Proposed	
Private Septic			Existing	Proposed	
Communal Septic			Existing	Proposed	
Other Provincial Waste Water System			Existing	Proposed	
How is storm drainage provided? * ✓ Storm Sewers ☐ Ditches ☐ Other means					
Existing Subject and Abutting Property La	nd Uses, Buildings and	their Locations			
What is the existing use of the subject property? Residential single family dwelling		What is the existing use of the abutting properties? Residential single family dwelling			
Provide the following details for all existing	g buildings on the sub	ject land			
Main Building Height in Meters N/A	Main Building Height N/A	in Feet	Percentage Lot Co	overage in Meters	
Percentage Lot Coverage in Feet N/A	Number of Parking S 4	paces	Number of Loadin	g Spaces	
Number of Floors	Total Floor Area in Sc 115.57	quare Meters	Total Floor Area in Square Feet 1244		
Ground Floor Area (Exclude Basement) in S 115.57	quare Meters	Ground Floor Are	rea (Exclude Basement) in Square Fee		
Provide the following details for all building	gs proposed for the su	ıbject land			
Main Building Height in Meters 2.65m	Main Building Height in Feet N/A		Percentage Lot Coverage in Meters 32.9%		
Percentage Lot Coverage in Feet 32.9%	Number of Parking S 2	paces	Number of Loading Spaces 0		
Number of Floors 1	Total Floor Area in Sc 8.4m2	quare Meters	Total Floor Area in Square Feet n/a		
Ground Floor Area (Exclude Basement) in Se	quare Meters	Ground Floor Are	a (Exclude Basement) i	n Square Fee	

What is the location of all buildings existing lot lines)	ing and proposed for th	e subject property? (s	specify distances from front, rear and sid	
Front Yard in Meters N/a	Front Yard in Feet 8 ft		Rear Yard in Meters N/a	
Rear Yard in Feet 8ft	Side Yard (interior) in Om	n Meters	Side Yard (interior) in Feet n/a	
Side Yard (Exterior) in Meters n/a		Side Yard (Exterior) in Feet n/a		
What are the dates of acquisition and con	nstruction of subject pr	roperty and building p	roperty	
Date of acquisition of subject property June 9 2023	Date of construction property 2004	of buildings	How long have the existing uses continued on the subject property? always	
Has the owner previously applied for relief in respect of the subject property?				
☐ Yes ✓ No				
Other Related Planning Applications				
Planning Application: Official Plan Amendr	ment	Planning Application	: Zoning By-Law Amendment	
Yes V No		☐ Yes ☑ No		
Planning Application: Plan of Subdivision		Planning Application: Consent (Severance)		
Yes V No		☐ Yes ✔ No		
Planning Application: Site Plan		Planning Application: Minor Variance		
☐ Yes ✔ No		☐ Yes ☑ No		
Minor Variance Application must be com	missioned			
Please confirm the following				
I understand that prior to the Minor Va owners or the agent responsible for the		g deemed complete it	must be commissioned by all registered	

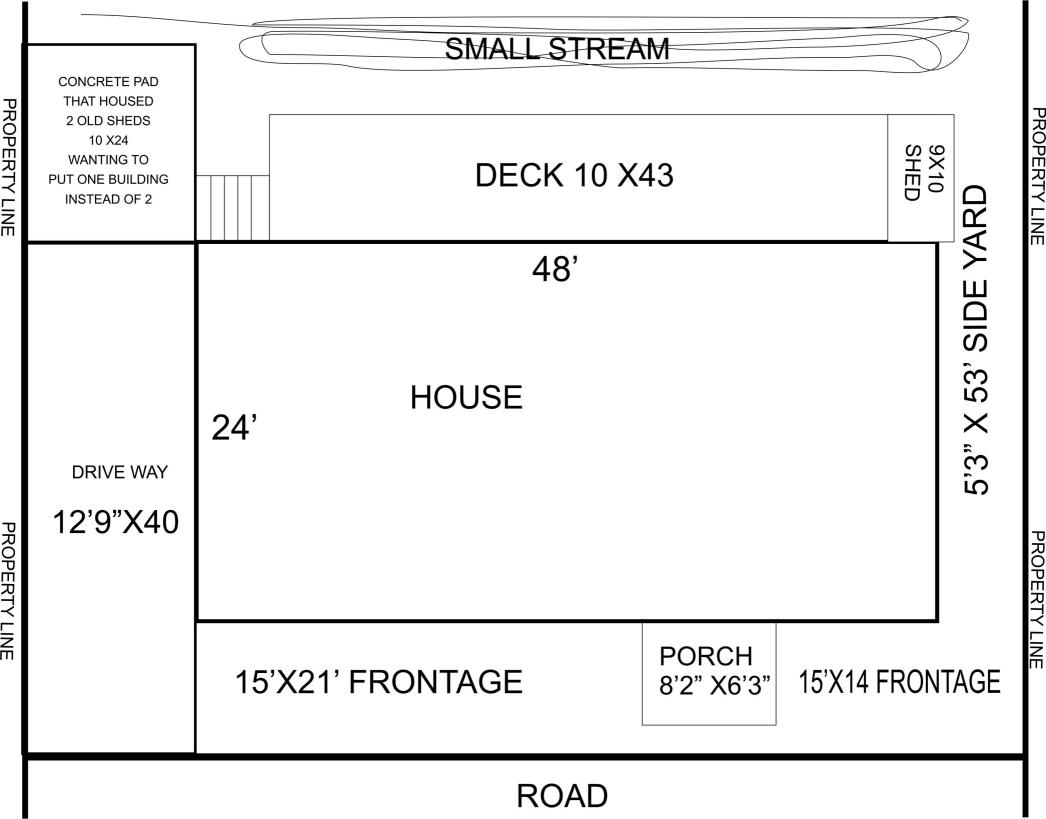



UTILITY SHED PLANS

ONTARIO - CANADA

GENERAL NOTES:

- 1. NATIONAL BUILDING CODE OF CANADA 2020 AND PROVINCIAL CODE OF ONTARIO AND ALL SUPPLEMENTS AND REVISIONS/ERRATA.
- 2. ALL MATERIALS AND LABOR SHALL BE IN ACCORDANCE WITH THE ABOVE CODE AND ALL OTHER APPLICABLE LOCAL CODES AT THE TIME OF MANUFACTURE.
- 3. WRITTEN DIMENSIONS SHALL TAKE PRECEDENCE OVER SCALED DIMENSIONS.
- 4. THE FOUNDATION PLAN IS A SEPARATE SET OF PLANS FOR APPROVAL BY LOCAL MUNICIPALITIES.
- 5. EXTERIOR DIMENSIONS CAN VARY BETWEEN LIMITS SHOWN @ 2'-0" o/c BUT MEMBER SPACING SHALL NOT EXCEED LIMITS AS INDICATED.
- 6. ALL THE FOLLOWING LUMBER SHALL BE PRESSURE TREATED IN ACCORDANCE WITH AWPA USE CATEGORY UC4B (GROUND CONTACT, HEAVY DUTY) SKIDS.
- 7. ALL THE FOLLOWING LUMBER SHALL BE PRESSURE TREATED IN ACCORDANCE WITH AWPA USE CATEGORY UC3B (EXTERIOR ABOVE GROUND, UNCOATED OR POOR WATER RUNOFF), FLOORS JOISTS, PLYWOOD FLOOR DECKING, AND EXTERIOR RATED WOOD STRUCTURAL PANEL SIDING. TREATED SOUTHERN YELLOW PINE MAY BE USED AS AN APPROVED MATERIAL (SEE PAGE 11 OF DRAWINGS FOR APPROVAL LETTER).
- 8. LP PROSTRUCT SUB-FLOORING 11/32" MAY BE USED IN LIEU OF PRESSURE TREATED PLYWOOD FLOORING.
- 9. P.T. PLYWOOD FLOORING NOT REQUIRED WHERE THE BOTTOM OF THE FLOORING IS OVER 18" ABOVE GROUND.
- 10. ALL FASTENERS AND CONNECTORS IN CONTACT WITH PRESSURE TREATED WOOD SHALL BE HOT DIPPED GALVANIZED (G185) OR STAINLESS STEEL.
- 11. FOR ROOFS WITH ASPHALT SHINGLES AND A SLOPE BETWEEN 2 TO 12 AND 4 TO 12 SHALL HAVE A DOUBLE UNDERLAYMENT APPLICATION AS REQUIRED IN ACCORDANCE TO NBCC 2020.
- 12. ASPHALT SHINGLES SHALL CONFORM TO NBCC 2020.
- 13. FASTENERS FOR ASPHALT SHINGLES SHALL CONFORM TO NBCC 2020.

THE INTEGRITY OF THE BUILDING AND ITS COMPONENT PARTS.

- 14. TIE-DOWNS SHALL MEET THE REQUIREMENTS OF ALL APPLICABLE CODES.
- 15. THE CONTRACTOR SHALL BE RESPONSIBLE FOR VERIFYING ALL EXISTING CONDITIONS.

ERROR OR OMISSIONS IN THE PERFORMANCE OF THE WORK BY THE CONTRACTOR.

- 16. THE CONTRACTOR SHALL BE RESPONSIBLE FOR DELIVERY AND PLACEMENT OF LAWN STORAGE UNIT TO INSURE
- 17. NO FIELD REVISIONS TO ANY STRUCTURAL COMPONENT OR DEVIATION FROM THESE DRAWINGS SHALL BE MADE.
- 18. THE OWNER AND THE CONTRACTOR SHALL HOLD HARMLESS THE ENGINEER FROM AND AGAINST ALL LIABILITY CLAIMS, DAMAGES, LOSSES AND EXPENSES INCLUDING LEGAL FEES ARISING OUT OF OR RESULTING FROM
- 19. SECTIONS AND DETAILS ON THE DRAWINGS ARE INTENDED TO BE TYPICAL AND SHALL APPLY AT ALL SIMILAR LOCATIONS, UNLESS OTHER SECTIONS AND DETAILS ARE SPECIALLY REFERENCED.
- 20. REFER TO SUPPLIED FASTENING SCHEDULE FOR FASTENING BASE ON CONNECTION AND LOCATION OF MEMBERS AS PER 2020 BUILDING CODE TABLE 2304.9.1 UNLESS NOTED OTHERWISE.
- 21. BUILDINGS HAVE BEEN DESIGNED FOR LP SMARTSIDE PREVISION PANEL SIDING, LP SMARTSIDE PRECISION LAP SIDING SHALL NOT BE USED.
- 22. FASTENERS IN LP SMARTSIDE PRECISION PANEL SIDING MUST NOT BE INSTALLED IN PANEL SIDING GROOVES IN THE FIELD OF THE PANEL SIDING OR WHEN THE PANEL SIDING GROOVES OCCUR AT CUT EDGES OF THE PANEL
- 23. REFER TO THE ICC-ES EVALUATION REPORT ESR-1301 FOR ADDITIONAL DATA AND SPECIFICATIONS OF LP SMARTSIDE PRECISION PANEL SIDING. MINNESOTA PRODUCT APPROVAL 9190.5 & 9190.6
- 24. MAX OPENING WIDTHS MUST COMPLY WITH DESIGN RATIOS AS PER ANSI/AF&PA SDPWS-2008. BUILDING HAVE DESIGNED TO HAVE ONLY OPENINGS WITH MAX WIDTHS EQUAL TO THOSE IN THE ENDWALL SHEAR WALL CHART.
- 25. THE DESIGN OF THESE BUILDING MEETS CNRC-NRC (CANADA NATIONAL RESEARCH COUNCIL), AND THE (PROVINCIAL BUILDING CODE).
- 26. BUILDING HAVE BEEN DESIGNED TO HAVE ANCHORS DIRECTLY ATTACHED TO ALL FOUR CORNERS OR THE BUILDING TO RESIST TENSION FORCES FROM LATERAL WIND LOADS, THIS DESIGN CONSIDERATION MUST BE MADE BY INSTALLER WHEN ATTACHING ANCHORING SYSTEM TO BUILDING.
- 27. UNLESS NOTED OTHERWISE, ATTACH ALL MANUFACTURED PRODUCTS IN ACCORDANCE WITH MANUFACTURERS SPECIFICATIONS.

NOTES:

THIS BUILDING DOES NOT HAVE RUNNING WATER OR SANITATION SERVICES. THIS BUILDING IS DESIGNED AS A UTILITY SHED TO STORE LAWN EQUIPMENT SUCH AS WHEEL BARROWS GARDENING SUPPLIES, FLOWER POTS, AD CARDBOARD BOXED WITH VARIOUS SMALL ITEMS.


SITE INSTALLED ITEMS:

NOTE THAT THIS LIST DOES NOT NECESSARILY LIMIT THE ITEMS OF WORK AND MATERIALS THAT MAY BE REQUIRED FOR A COMPLETE INSTALLATION. ALL SITE RELATED ITEMS ARE SUBJECT TO LOCAL JURISDICTIONAL APPROVAL.

- 1. THE COMPLETE FOUNDATION SUPPORT AND TIE-DOWN SYSTEM.
- 2. RAMPS, STAIRS, AND GENERAL ACCESS TO THE BUILDING IF NECESSARY.
- 3. GUTTERS AND DOWNSPOUTS ON ALL BUILDINGS WITH EAVES OF LESS THAN 6 INCHES HORIZONTAL PROJECTION EXCEPT FOR GABLE END RAKES.
- 4. ANCHORS & PADS ARE OPTIONAL, TO BE DETERMINED BY LOCAL CONDITIONS AND BUILDING PROFESSIONALS.




WIND CHART

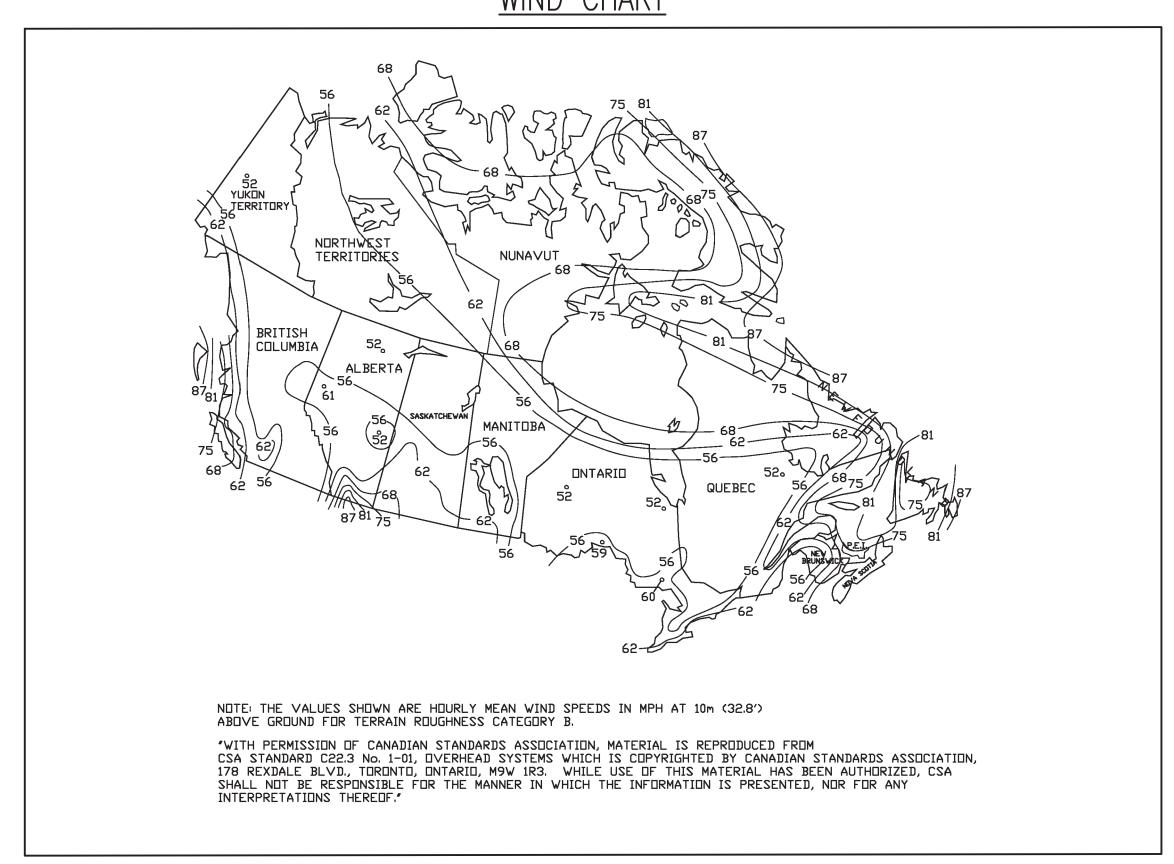

	<u>DESIGN</u> C	CRITERIA:
1.	WIND VELOCITY	1/50 kPA. Column Div B App C 75 mph = 14.4 psf
2.	BUILDING CATEGORY	1
3.	WIND EXPOSURE	С
4.	INT. PRESSURE COEFFICIENT	±0.18
5.	ENCLOSURE CLASSIFICATION	ENCLOSED
6.	BASED ON HEIGHT	15 FEET
7.	OVERHANG	NO
8.	FLOOR DESIGN LIVE LOAD FLOOR DESIGN DEAD LOAD	50 PSF 4 PSF
9.	ROOF DESIGN LIVE LOAD ROOF DESIGN DEAD LOAD	
10.	WALL DESIGN DEAD LOAD	3 PSF
11.	SNOW LOAD IF SS: TRUSSES/ RAFTERS AT 12" FOR	S=0.8 (0.8SS+SR) Ss<4.4kpa >4.4, (67 psf) SPECIAL ORDER. SNOW BETWEEN 67 & 85 PSF
12.	CONSTRUCTION TYPE	<u>V</u> B
13.	BUILDING OCCUPANCY =	U
14.	FIRE RATING EXT. WALLS	0
15.	ALLOWABLE NUMBER OF FLOORS	1
16.	THE CONTRACTOR / MANUFACTURE CODES AND ALL OF THEIR AMENDM	R MUST COMPLY WITH THE FOLLOWING IENTS / SUPPLEMENTS.

CANADA CODE SUMMARY LATEST BUILDING CODE 2020 NBCC

	SHEET LIST
SHEET NUMBER	SHEET TITLE
C-1	COVER SHEET
C-2	FASTENING SCHEDULE / WIND LOADING / SHEARWALL CHART
A-1	FRAMING PLANS & DETAILS
A-2	FRAMING PLANS & DETAILS
A-3	SECTIONS
A-4	PLANS & DETAILS
A-5	TYPICAL DETAILS
A-6	TYPICAL DETAILS
A-7	OPTIONAL PORCH DETAILS
A-8	ANCHORING DETAILS & SCHEDULES
A-9	ANCHORING SPEC SHEETS
A-10	TRUSS DETAILS

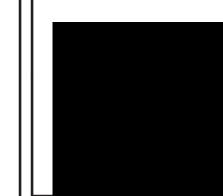

PROJECT

UTILITY SHED

AREA FOR APPROVAL STAMPS

COVER SHEET & GENERAL NOTES

DON VAN GERVE, P.E. SPECIALTY STRUCTURAL ENGINEER



ENGINEERING SERVICES PROVIDED FOR:

PREMIER PORTABLE BUILDINGS

317 EAST STATE LINE ROAD


SOUTH FULTON, TN 38257

WWW.PREMIERBUILDINGS.US

REVISION	DESCRII	PTION	DATE	BY
1				
/2				
/3				
<u>/4</u> /5				
DATE:	6.30.24			
PROJECT NO	:: 18285			
DRAWING BY:	: JH			
CHK BY:	DVG			
DWG NO.:				
(C-1			
]		

1 of 12

CONNECTION	<u>FASTENING</u>		<u>LOCATION</u>	BUILD
1. JOIST TO SILL OR GIRDER	3 - 8d COMMON (2½"x) 3 - 3"x0.131" NAILS 3 - 3" 14 GAGE STAPL		TOE-NAIL	- <u>WID</u>
2. BRIDGING TO JOIST	2 - 8d COMMON (2½"x) 2 - 3"x0.131" NAILS 2 - 3" 14 GAGE STAPL		TOE-NAIL EACH END	8'-(
3. SOLE PLATE TO JOIST OR BLOCKING	16d (3½"x0.135") @ 16 3"x0.131" NAILS @ 8" o 3" 14 GAGE STAPLES @	o/c	TYPICAL FACE NAIL	10'-
4. SOLE PLATE TO JOIST OR BLOCKING @ BRACED WALL PANEL	3 - 16d (3½"x0.135") 4 - 3"x0.131" NAILS @ 4 - 3" 14 GAGE STAPL	16" o/c	BRACED WALL PANELS	11'-
5. TOP PLATE TO STUD	2 - 16d (3½"x0.162") 3 - 3"x0.131" NAILS 3 - 3" 14 GAGE STAPL	LES	END NAIL	
	4 - 8d COMMON (2½"x 4 - 3"x0.131" NAILS 3 - 3" 14 GAGE STAPL		TOE-NAIL	14'-
6. STUD TO SOLE PLATE	2 -16d COMMON (3½"x) 3 - 3"x0.131" NAILS 3 - 3" 14 GAGE STAPL		END NAIL	16'-
7. DOUBLE STUDS	16d (3½"x0.135") @ 24 3"x0.131" NAILS @ 8" o 3" 14 GAGE STAPLES @	o/c	FACE NAIL	
	16d (3½"x0.135") @ 16 3"x0.131" NAILS @ 12" 3" 14 GAGE STAPLES @	o/c	TYPICAL FACE NAIL	5
8. DOUBLE TOP PLATES	8 -16d COMMON (3½"x) 12 - 3"x0.131" NAILS 12 - 3" 14 GAGE STAP		LAP SPLICE	
BLOCKING BETWEEN JOISTS OR TRUSSES TO TOP PLATE	3 — 8d COMMON (2½"x 3 — 3"x0.131" NAILS 3 — 3" 14 GAGE STAPL		TOE-NAIL	
O. TOP PLATES, LAPS AND INTERSECTIONS	2 - 16d (3½"x0.162") 3 - 3"x0.131" NAILS 3 - 3" 14 GAGE STAPL	ES	FACE NAIL	
11. CONTINUOUS HEADER (2) PIECES	8 −16d COMMON (3½"x)	(0.162")	16" o/c ALONG EDGE	1
12. CONTINUOUS HEADER TO STUD	4 −8d COMMON (2½"x0.).131")	TOE-NAIL	1
13. BUILT-UP CORNER STUDS	16d (3½"x0.135") @ 24 3"x0.131" NAILS @ 16" 3" 14 GAGE STAPLES @	o/c	@ 24" o/c @ 16" o/c @ 16" o/c	
	20d (4"x0.192") @ 32" 3"x0.131" NAILS @ 24" 3" 14 GAGE STAPLES @	o/c	FACE NAIL @ TOP & BOTTOM STAGGERED ON OPP. SIDES	
14. DOUBLE TOP PLATES	2 -20d COMMON (4"x0. 3 - 3"x0.131" NAILS 3 - 3" 14 GAGE STAPL	,	FACE NAIL @ ENDS AND AT EACH SPLICE	
15. JOIST TO BAND JOIST	3 - 16d COMMON (3½" 4 - 3"x0.131" NAILS 4 - 3" 14 GAGE STAPL	Í	FACE NAIL	
WOOD STRUCTURAL PANELS AND PARTICLE BOARD SUBFLOOR, ROOF AND WALL SHEATHING (TO FRAMING)	1¾" 19 ₃₂ " TO ¾" 8d ^d 2¾"	"x0.113" NAIL ⁱ " 16 GAGE ^M OR "x0.113" NAIL ⁿ		٧
SINGLE FLOOR (COMBINATION SUBFLOOR-UNDERLAYMNENT TO FRAMING)	8d ^c	16 GAGE ⁿ		
SINGLE FLOOR (COMBINATION SUBFLOOR-UNDERLAYMENT TO FRAMING)	¾" AND LESS 6d ^b ⅓" TO 1" 8d ^b			
17. 29ga. STEEL SIDING (TO FRAMING)	½" OR LESS 6d ^f %" 8d ^f		NAILS @ 6" o/c IN FIELD AND 3" o/c ALONG ALL PANEL EDGES.	
18. FIBERBOARD SHEATHING ⁹	6d	. 11 GAGE ROOFIN COMMON NAIL (2' 16 GAGE STAPLE'	"x0.113")	
	²⁵ ⁄ ₃₂ " NO. 8d	. 11 GAGE ROOFIN COMMON NAIL (2) 16 GAGE STAPLE	NG NAIL ^h ½"x0.131")	

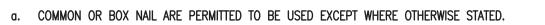

- NAILED SPACED @ 6" o/c AT EDGES, 12" AT INTERMEDIATE SUPPORTS EXCEPT 6" AT SUPPORTS WHERE SPANS ARE 48" OR MORE, FOR NAILING OF WOOD STRUCTURAL PANEL AND PARTICLE BOARD DIAPHRAGMS AND SHEAR WALLS, REFER TO SECTION 2305 FBC. NAILS FOR WALL SHEATHING ARE PERMITTED TO BE COMMON, BOX OR CASING.
- c. COMMON OR DEFORMED SHANK (6d -2"x0.113"; 8d $-2\frac{1}{2}$ "x0131"; 10d 3"x0148").
- d. COMMON (6d 2"x0.113";8d-2½"x0131"; 10d 3"x0.148").

SHEARWALL CHART

 $T1 - 11^{1}$

24'-0"

30'-0"

36'-0"

28-0**"**

40'-0"

40'-0"

MAX. LENGTH OF BUILDING

SMARTSIDE PANEL²

20**'**-0"

30'-0"

16'-0"

24'-0"

12**'**-0"

40'-0"

34'-0"

20**'**-0"

30'-0"

and the state of t

Case B

Gable Roof (7° $< \theta \le 45^\circ$)

ALUMINUM OVER

⅓₆" OSB⁴

30'-0"

36'-0"

40'-0"

40'-0"

OPENING WIDTHS IN

ENDWALL

3'-0" MAX.

3'-0" MAX.

6'-0"

3'-0" MAX.

6'-0"

9'-0"

3'-0" MAX.

6'-0"

9'-0"

6'-0" MAX.

9'-0"

Case A

Gable Roof (θ ≤ 7°)

G.F.I.

OUTLET

SOURCE

FIGURE 1609.6.2.2

COMPONENT AND CLADDING PRESSURE


NOTES-OPTIONAL ELECTRIC

WIRING DIAGRAM

(OPTIONAL)

-ALL WIRING SHALL BE 14 GAGE 3-WIRE MC CABLE. -ENCASE IN ALL METAL BOXES.

- e. DEFORMED SHANK (6d-2"x0.113"; 8d 2½"x0.131" 10d 3"x0.148").
- CORROSION-RESISTANT SIDING (6D-1%"x0.106";8d 2%"x0.128") OR CASING (6D2"x0.099";8d 2 ½"x0.113") NAIL. g. FASTENERS SPACED 3" o/c AT EXTERIOR EDGES AND 6" o/c AT INTERMEDIATE SUPPORTS WHEN USED AS STRUCTURAL
- h. CORROSION-RESISTANT ROOFING NAILS w/ $\frac{7}{16}$ " DIAMETER HEAD AND 1 $\frac{1}{2}$ " LENGTH FOR $\frac{1}{2}$ " SHEATHING AND 1 $\frac{3}{4}$ " LENGTH FOR 25 /₃₂" SHEATHING.
- CORROSION-RESISTANT STAPLES WITH NOMINAL $\frac{7}{6}$ CROWN OR 1" CROWN AND 1 $\frac{1}{4}$ " LENGTH FOR $\frac{1}{2}$ " SHEATHING AND 1 $\frac{1}{2}$ " LENGTH FOR 25/32" SHEATHING. PANEL SUPPORTS @ 16" o/c(20" IF STRENGTH AXIS IS THE LONG DIRECTION OF THE PANEL, UNLESS OTHERWISE MARKED.)
- FOR ROOF SHEATHING APPLICATIONS, 8d NAILS (2½"x0.113") ARE THE MINIMUM REQUIRED FOR WOOD STRUCTURAL PANELS. k. STAPLES SHALL HAVE A MINIMUM CROWN WIDTH OF $\frac{1}{16}$ ".
- I. FOR ROOF SHEATHING APPLICATIONS, FASTENERS SPACED 4" o/c AT EDGES, 8" o/c AT INTERMEDIATE SUPPORTS.
- m. FASTENERS SPACED 4" o/c AT EDGES, 8" o/c AT INTERMEDIATE SUPPORTS FOR SUBFLOOR AND WALL SHEATHING AND 3" o/c AT EDGES, 6" AT INTERMEDIATE SUPPORTS FOR ROOF SHEATHING.
- n. FASTENERS SPACED 4" o/c AT EDGES, 8" AT INTERMEDIATE SUPPORTS.
- 1. 19/32" T1-11 SHALL BE FASTENED USING 8d COMMON OR DEFORMED NAILS @ 6" o/c IN FIELD AND 3" o/c ALONG ALL
- 2. 3/8" LP SMARTPANEL SHALL BE FASTENED USING 8d COMMON OR DEFORMED NAILS @ 6" o/c IN FIELD AND 3" oI/c ALONG ALL PANEL. EDGES.
- 3. LIMITATIONS ON THE TOTAL OPENING DIMENSIONS SHALL BE BASED ON THE SHEAR WALL HEIGHT TO WIDTH RATION OF 3.5:1 AND SHALL NOT EXCEED (3/3) OF TOTAL LENGTH OF BUILDING. NAILING IN SIDEWALL USE 8d NAILS COMMON OR DEFORMED AT 6" EVERYWHERE WHEN TOTAL OPENING WIDTHS IN SIDE WALL ARE LESS THAN (%) OF TOTAL LENGTH OF
- 4. 29ga. STEEL SIDING OVER 1/6" OSB FASTENED USING 8d COMMON OR DEFORMED NAILS @ 6" o/c IN FIELD AND 3" o/c ALONG ALL PANEL EDGES.

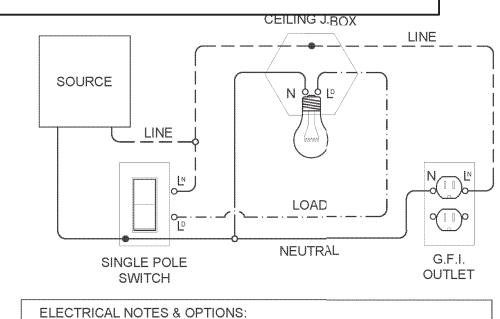



ELECTRICAL NOTES & OPTIONS: - AS PER NEX ARTICLE 330.30(B) SECURING OF MC TYPE CABLE. UNLESS OTHERWISE PROVIDED, CABLES SHALL BE SECURED AT INTERVALS NOT EXCEEDING 6FT. CABLES CONTAINING FOUR OR FEWER CONDUCTORS SIZED NO LARGER THAN 10 AWG SHALL BE SECURED WITHIN 12 IN. OF EVERY BOX, CABINET, FITTING, OR OTHER CABLE

- ALL WIRING SHALL BE 14 GAUGE 3-WIRE MC CABLE. - ENCASE IN ALL METAL BOXES.

MAXIMUM NO. OF OUTLETS: 7 MAXIMUM NO. OF LIGHTS:

ELECTRICAL WIRING DIAGRAM

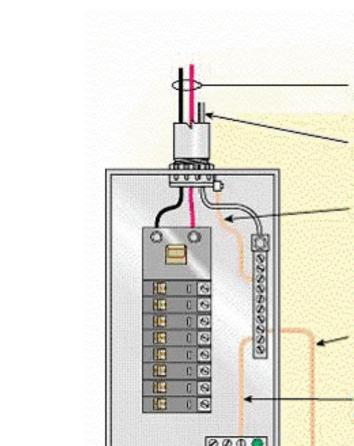

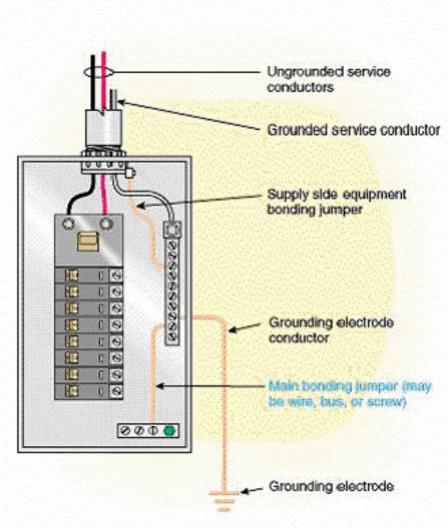



AREA FOR APPROVAL STAMPS

UTILITY SHED


FASTENING SCHEDULE / WIND LOADING


DON VAN GERVE, P.E. SPECIALTY STRUCTURAL ENGINEER





ENGINEERING SERVICES PROVIDED FOR: PREMIER PORTABLE BUILDINGS 317 EAST STATE LINE ROAD SOUTH FULTON, TN 38257 WWW.PREMIERBUILDINGS.US


1	REVISION	DESCRII	PTION	DATE	BY
١					
١	2				
١	3				
١	4				
١					
١	DATE:	6.30.24			
١	PROJECT NO	:: 18285			
١	DRAWING BY:	: JH			
١	CHK BY:	DVG			
١	DWG NO.:				
١	(C-2			
١		J- <u>C</u>			
١]		
١					
١					
١					
			1		
	2	2 of 12			

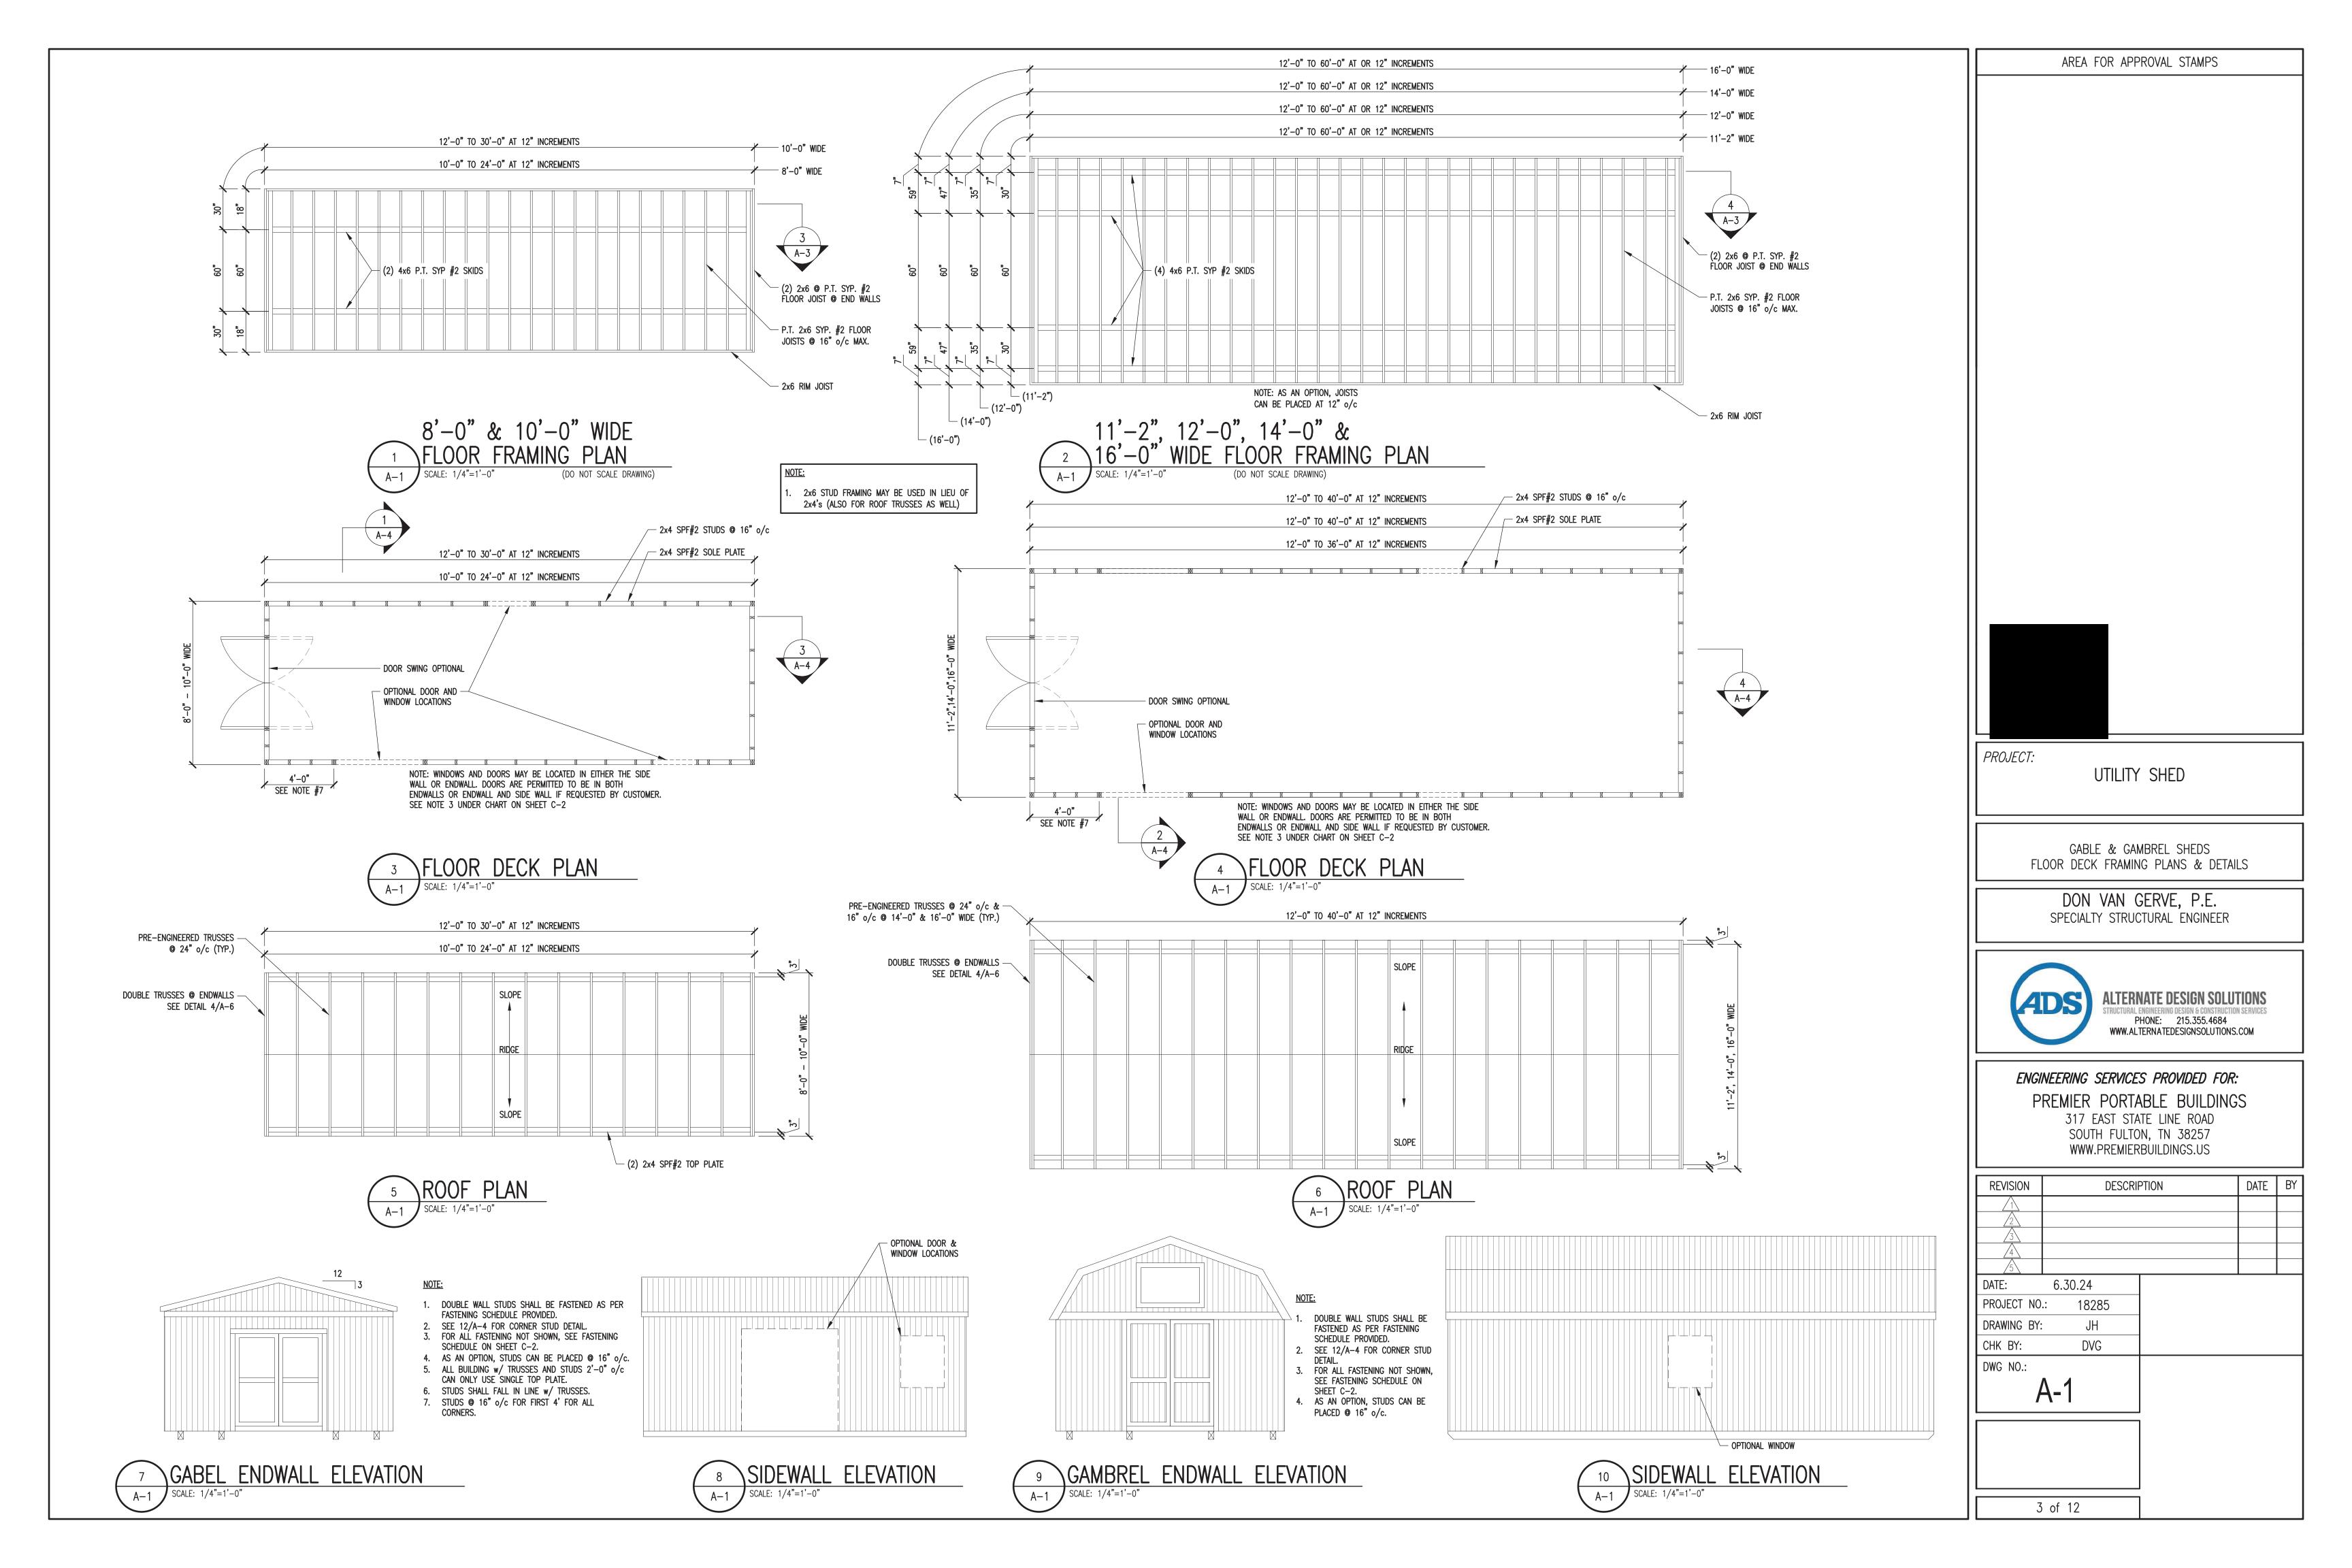


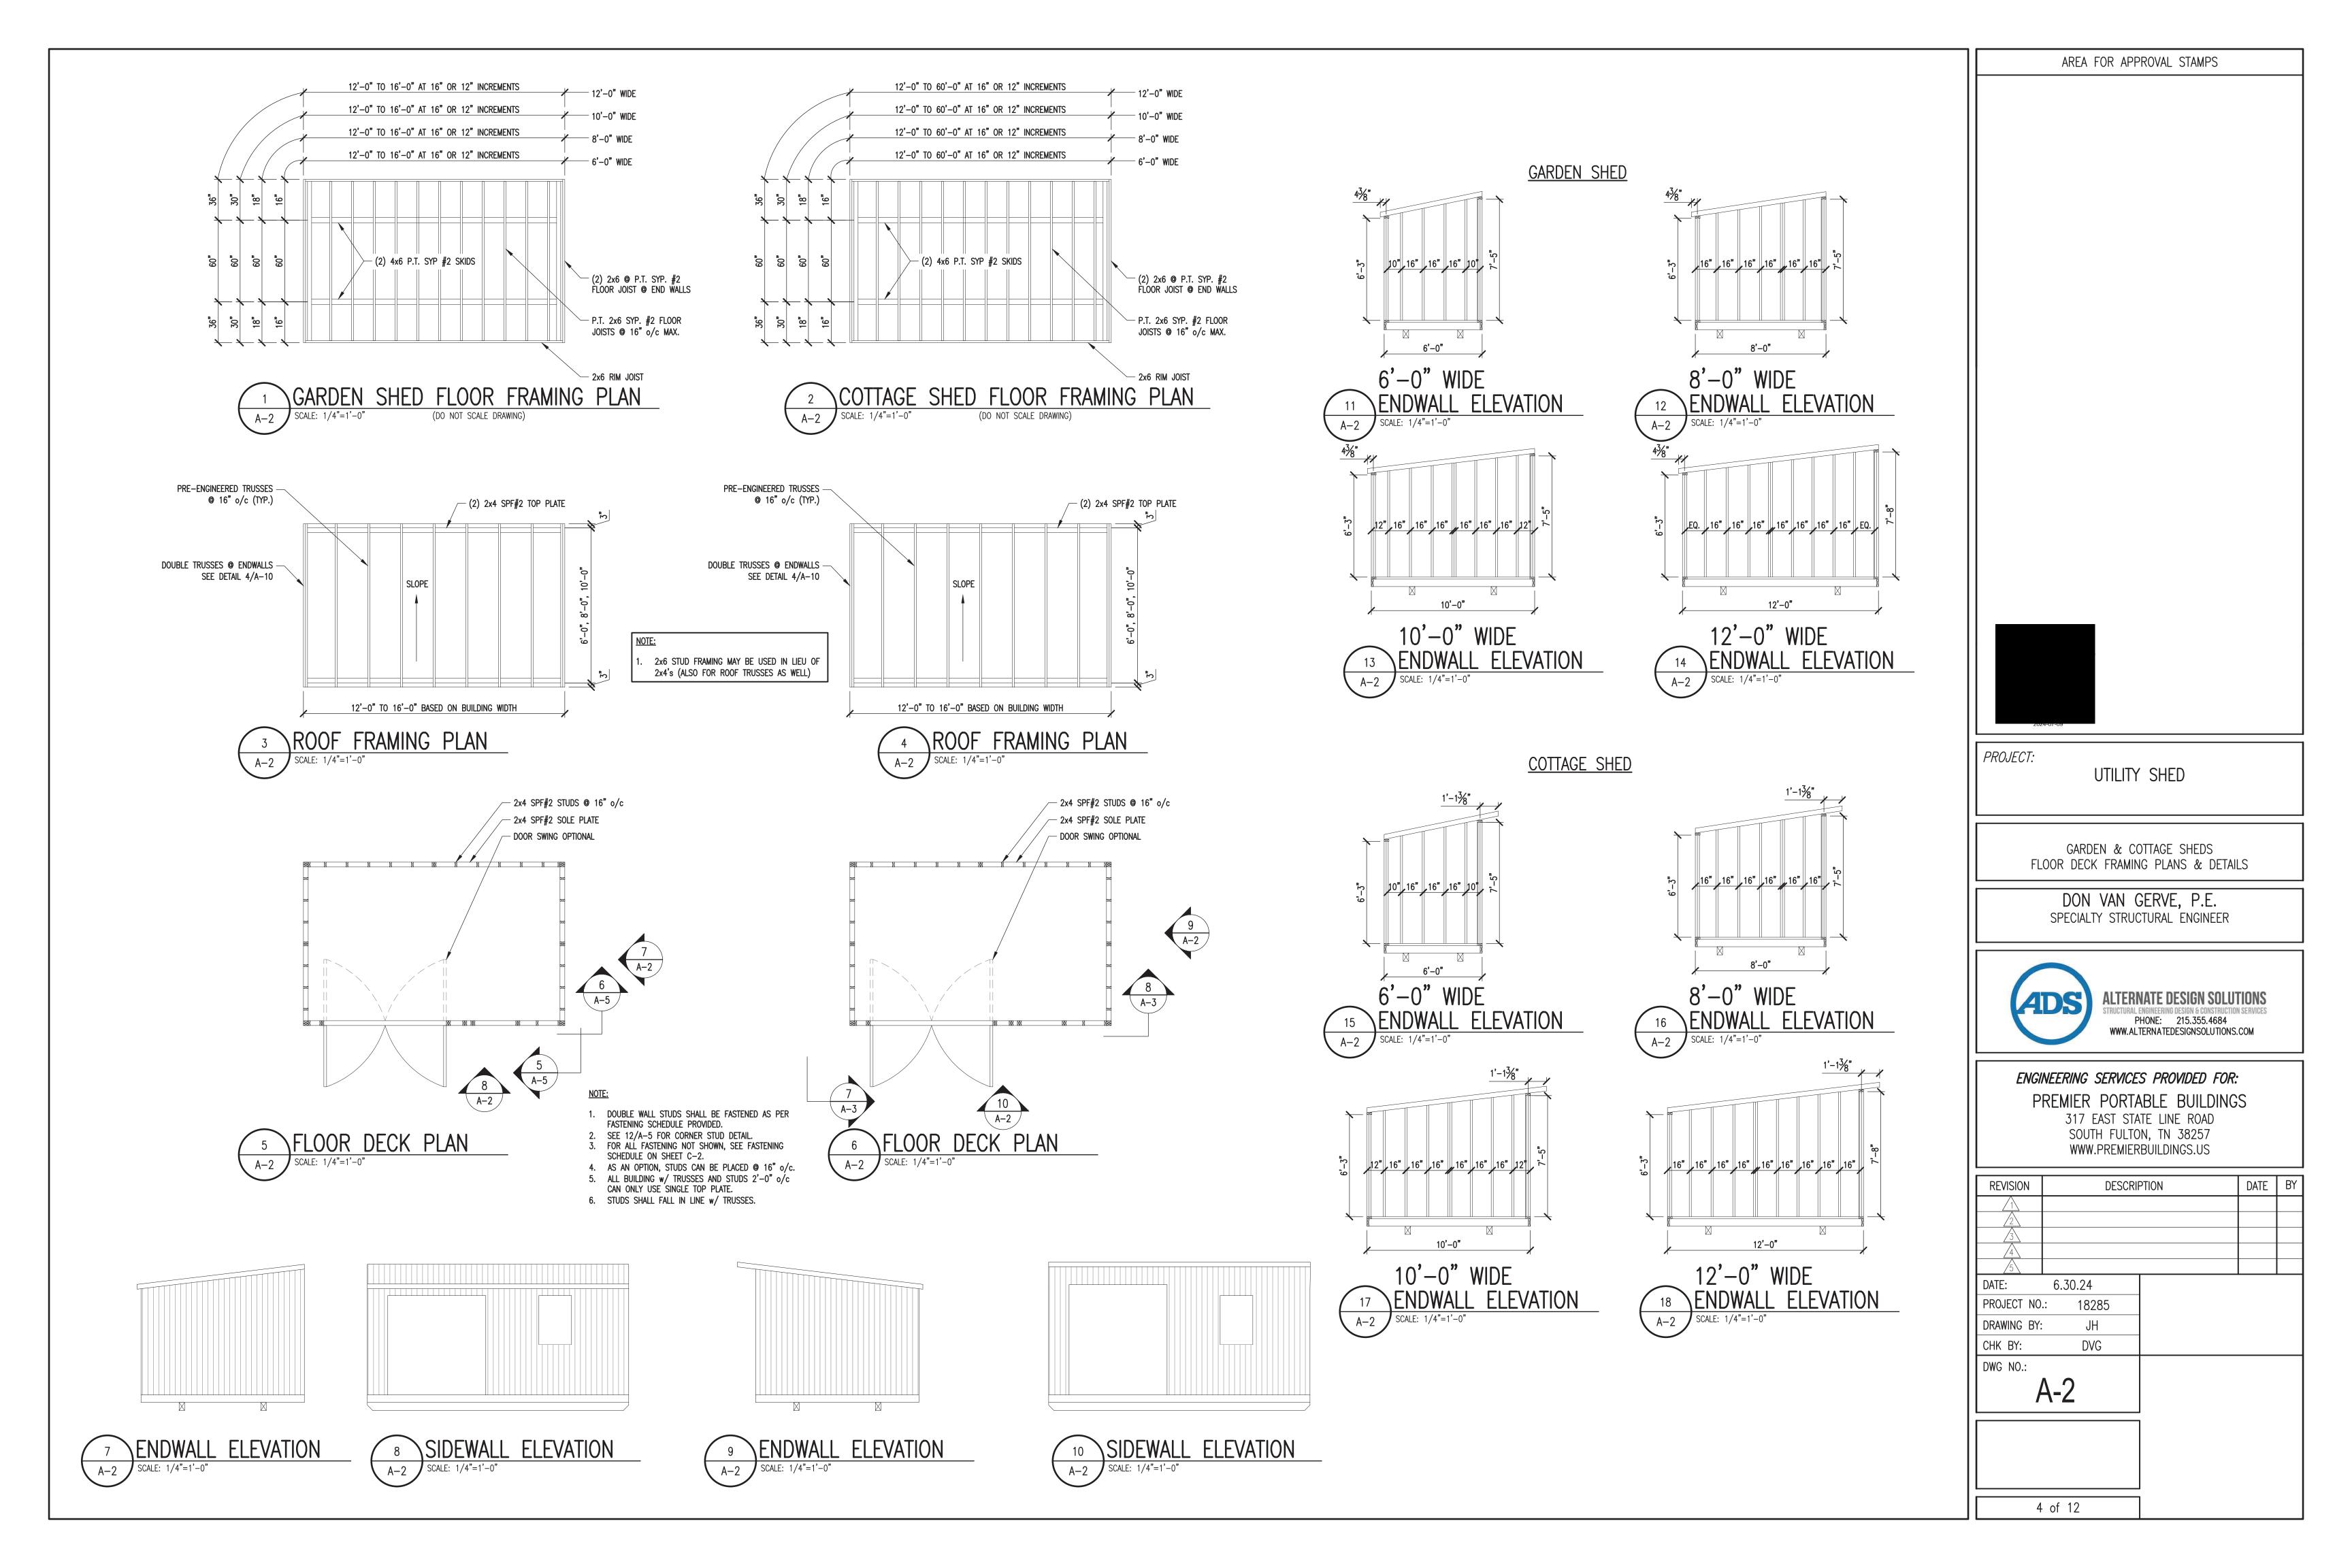


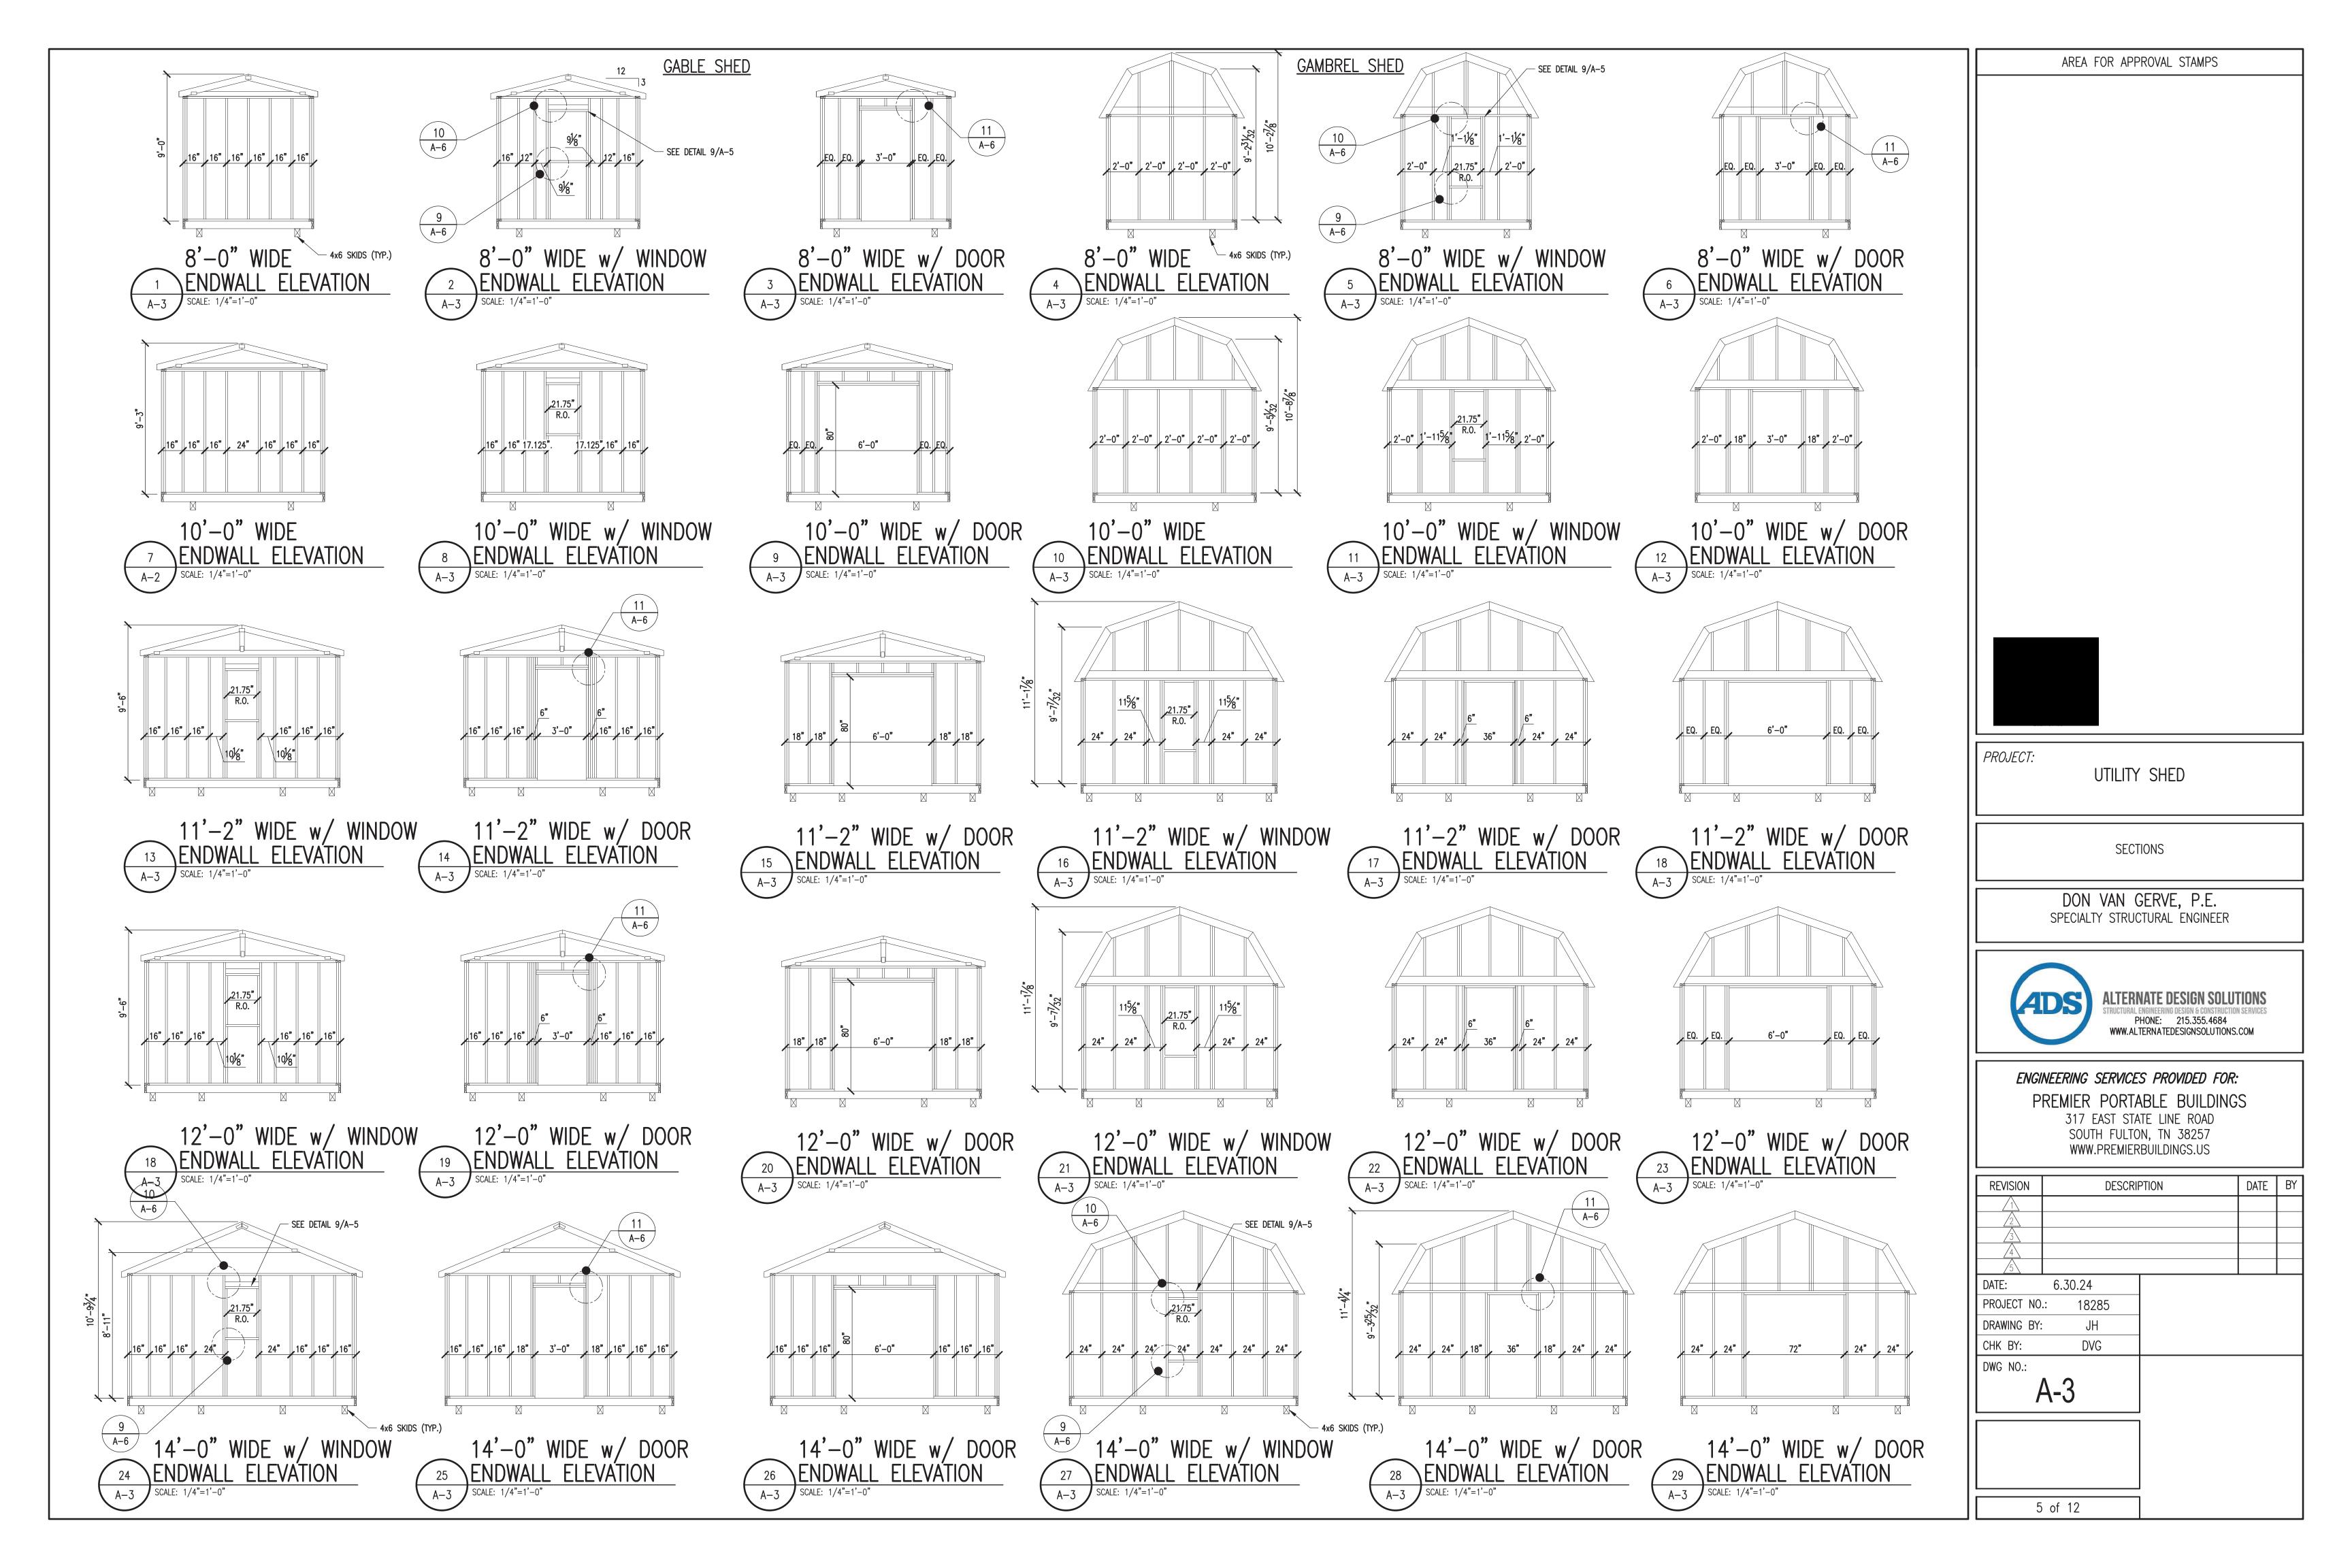


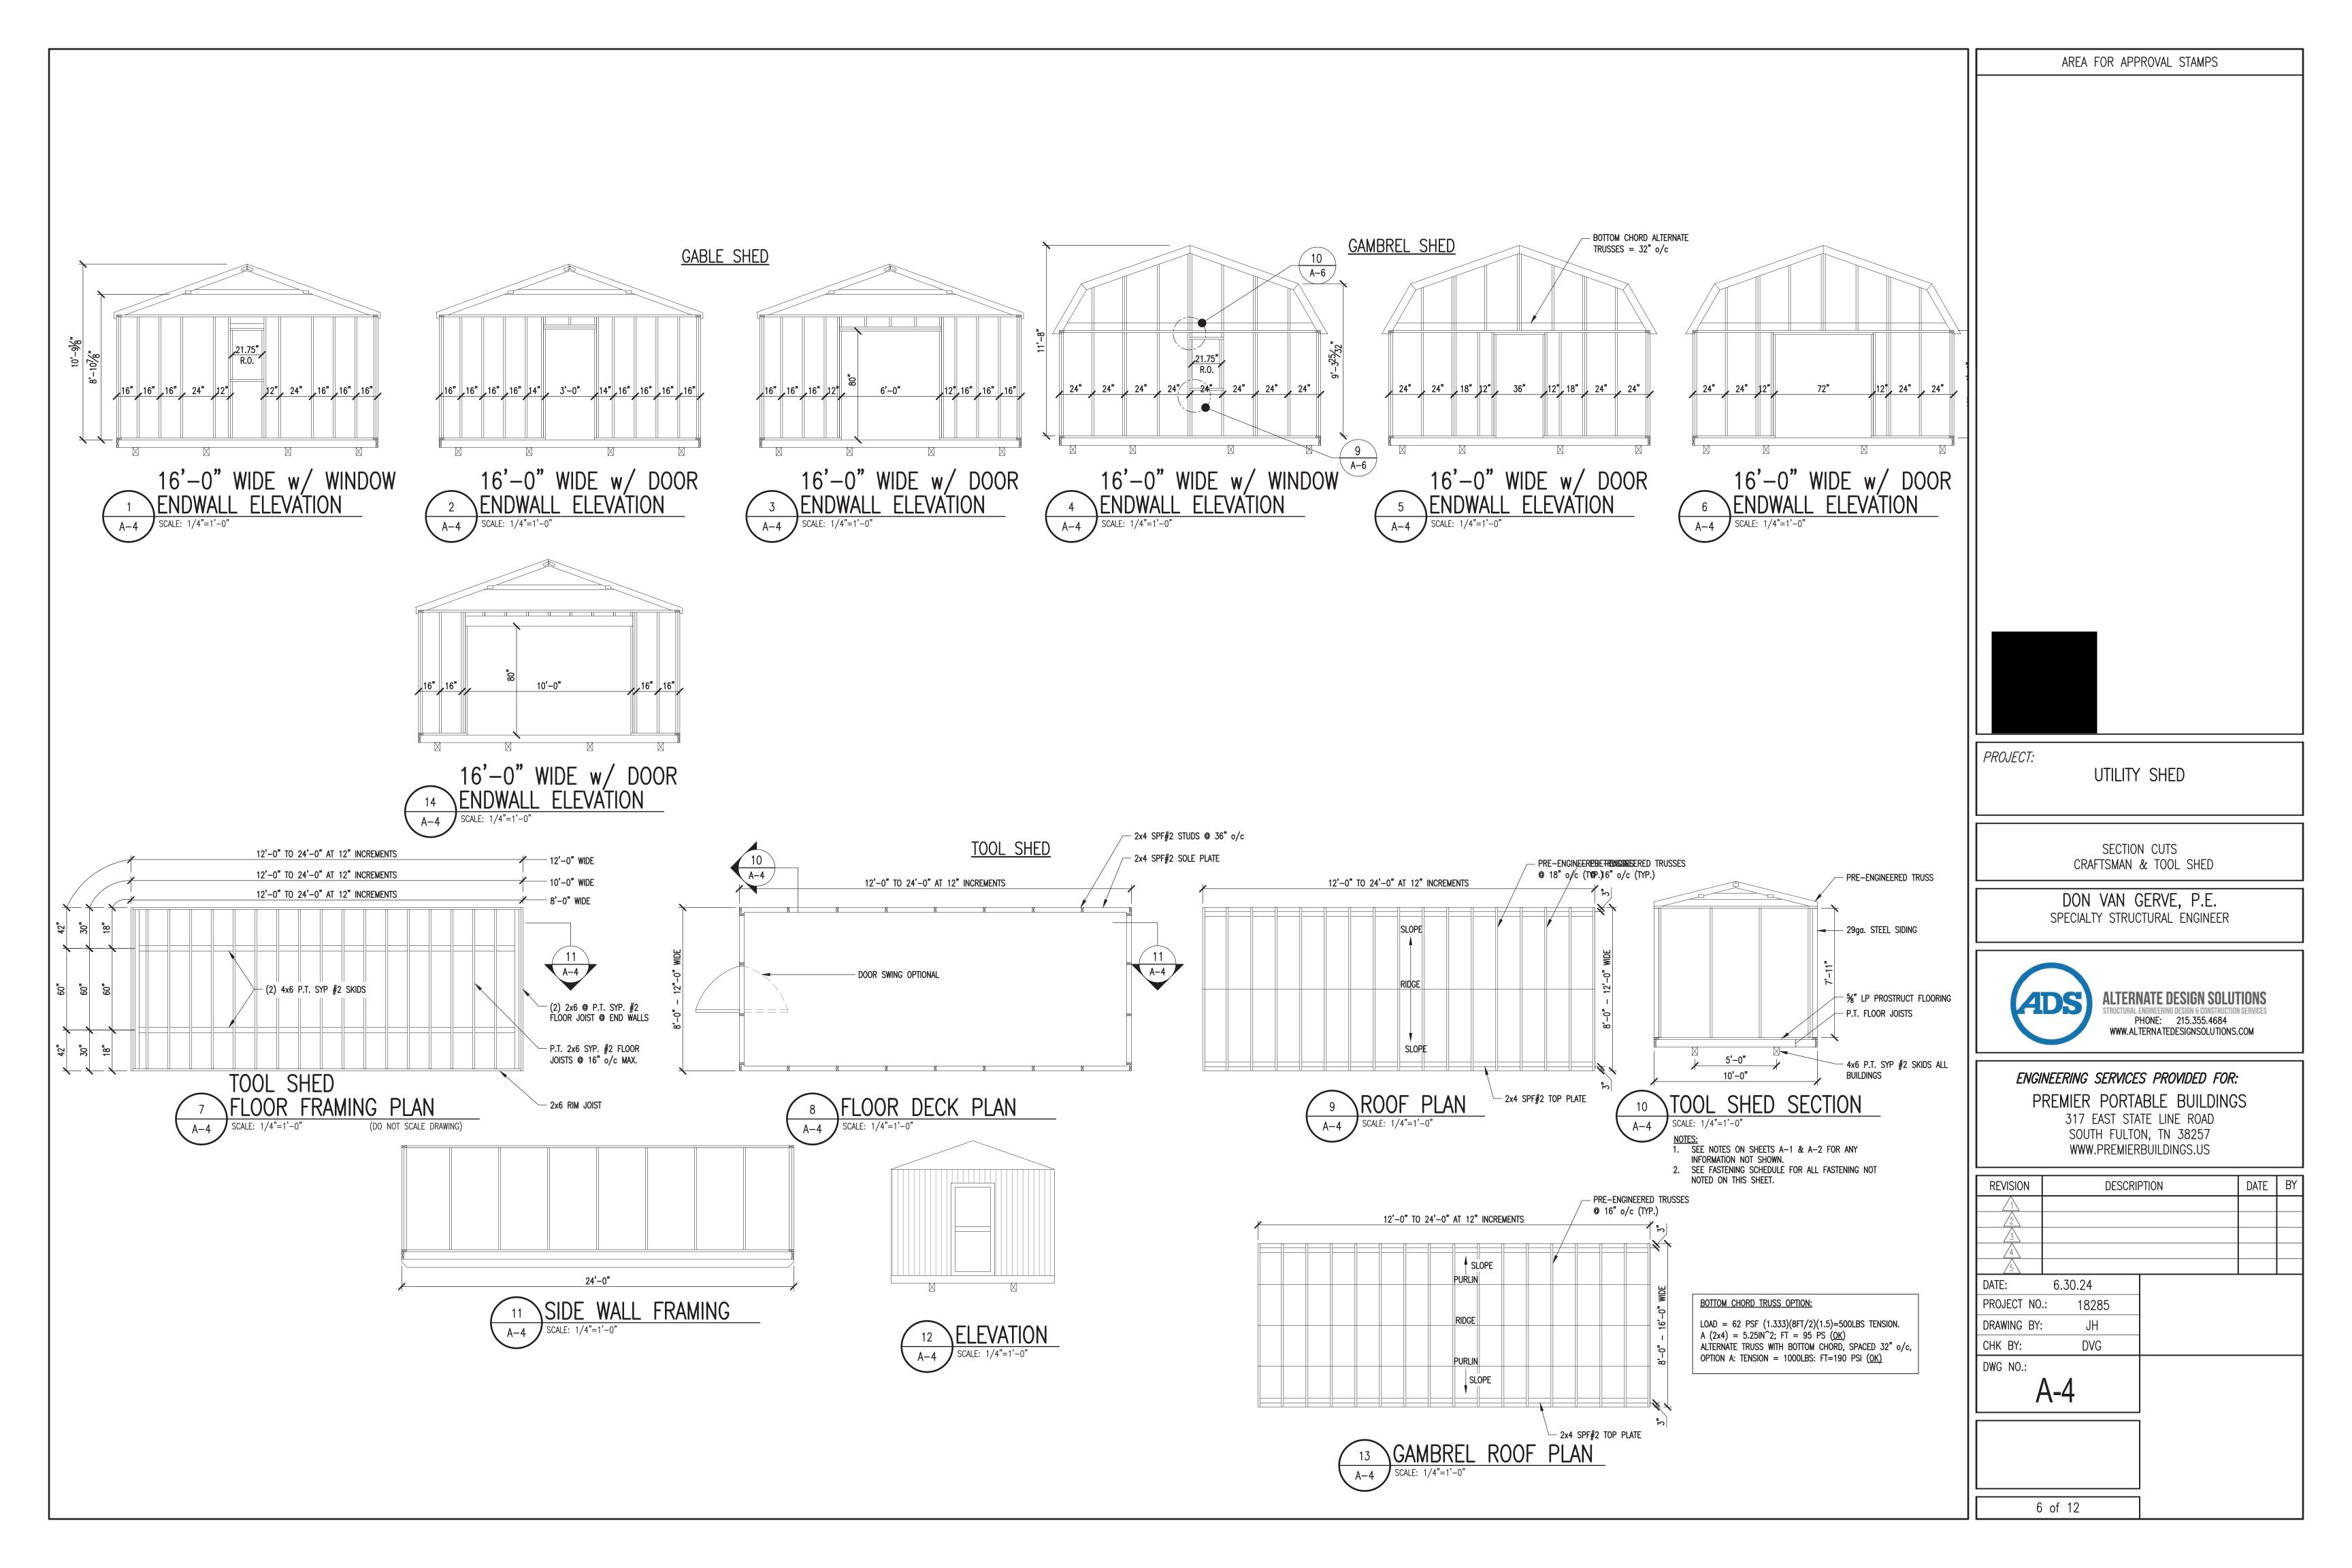

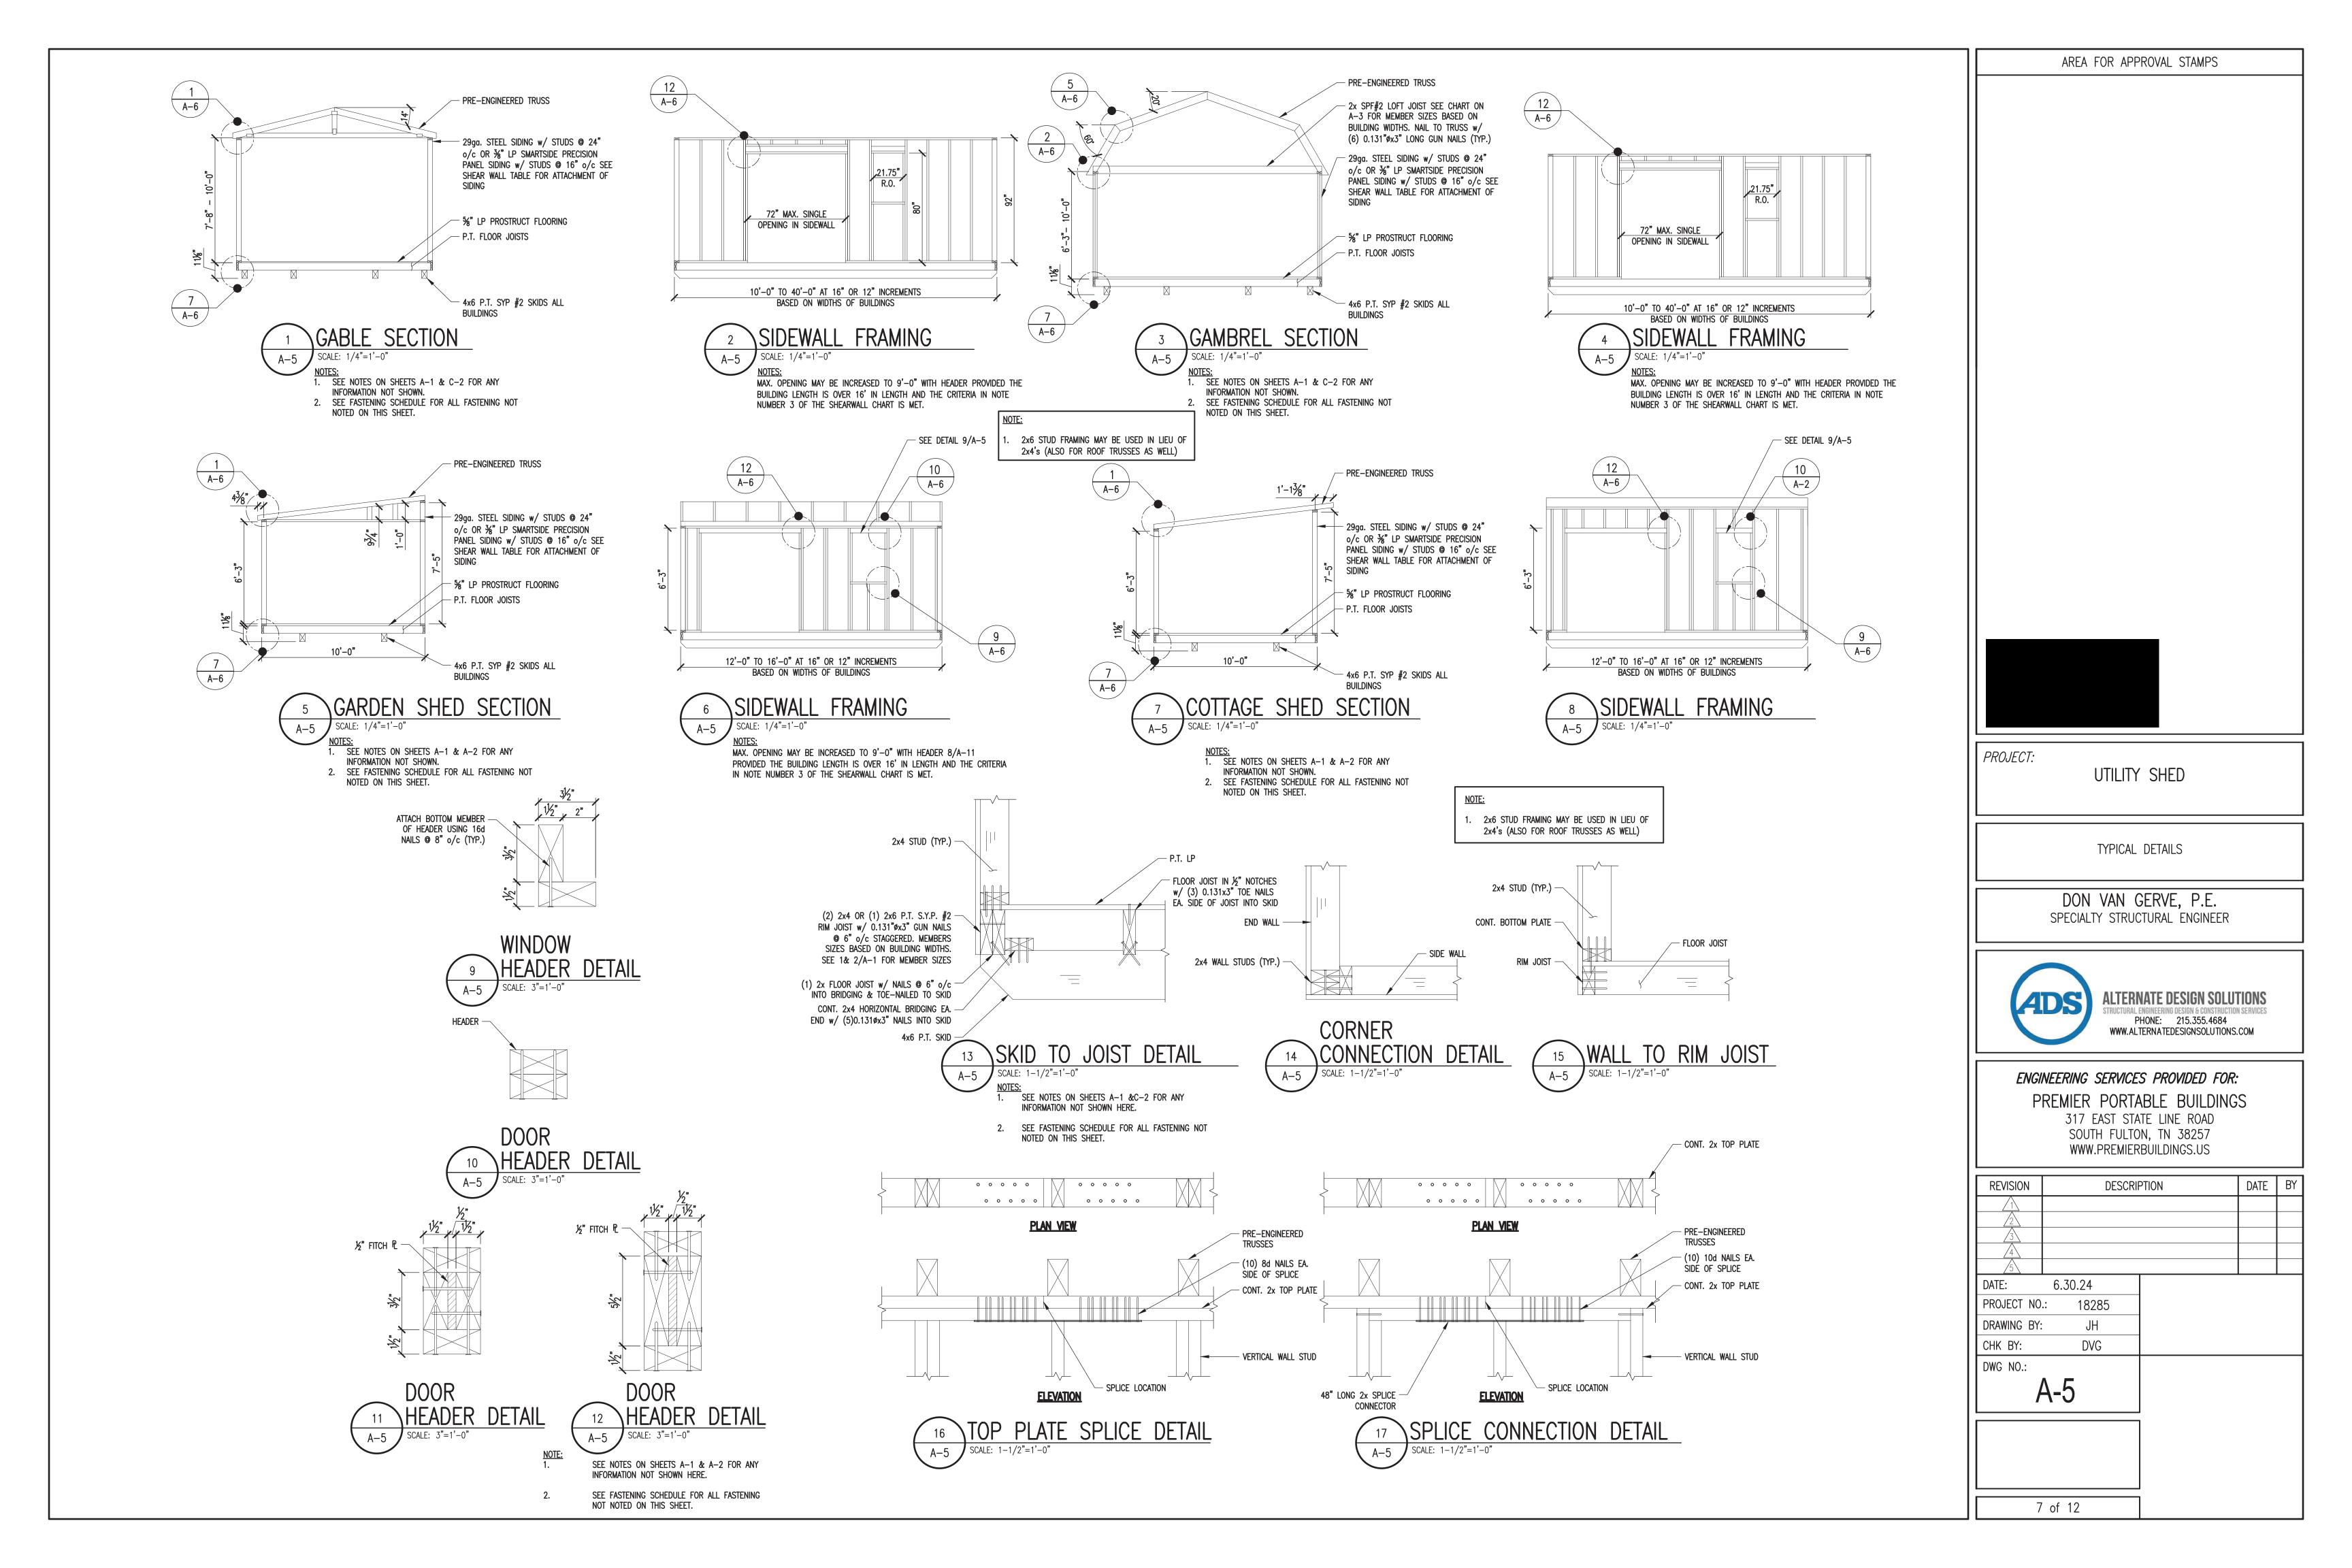

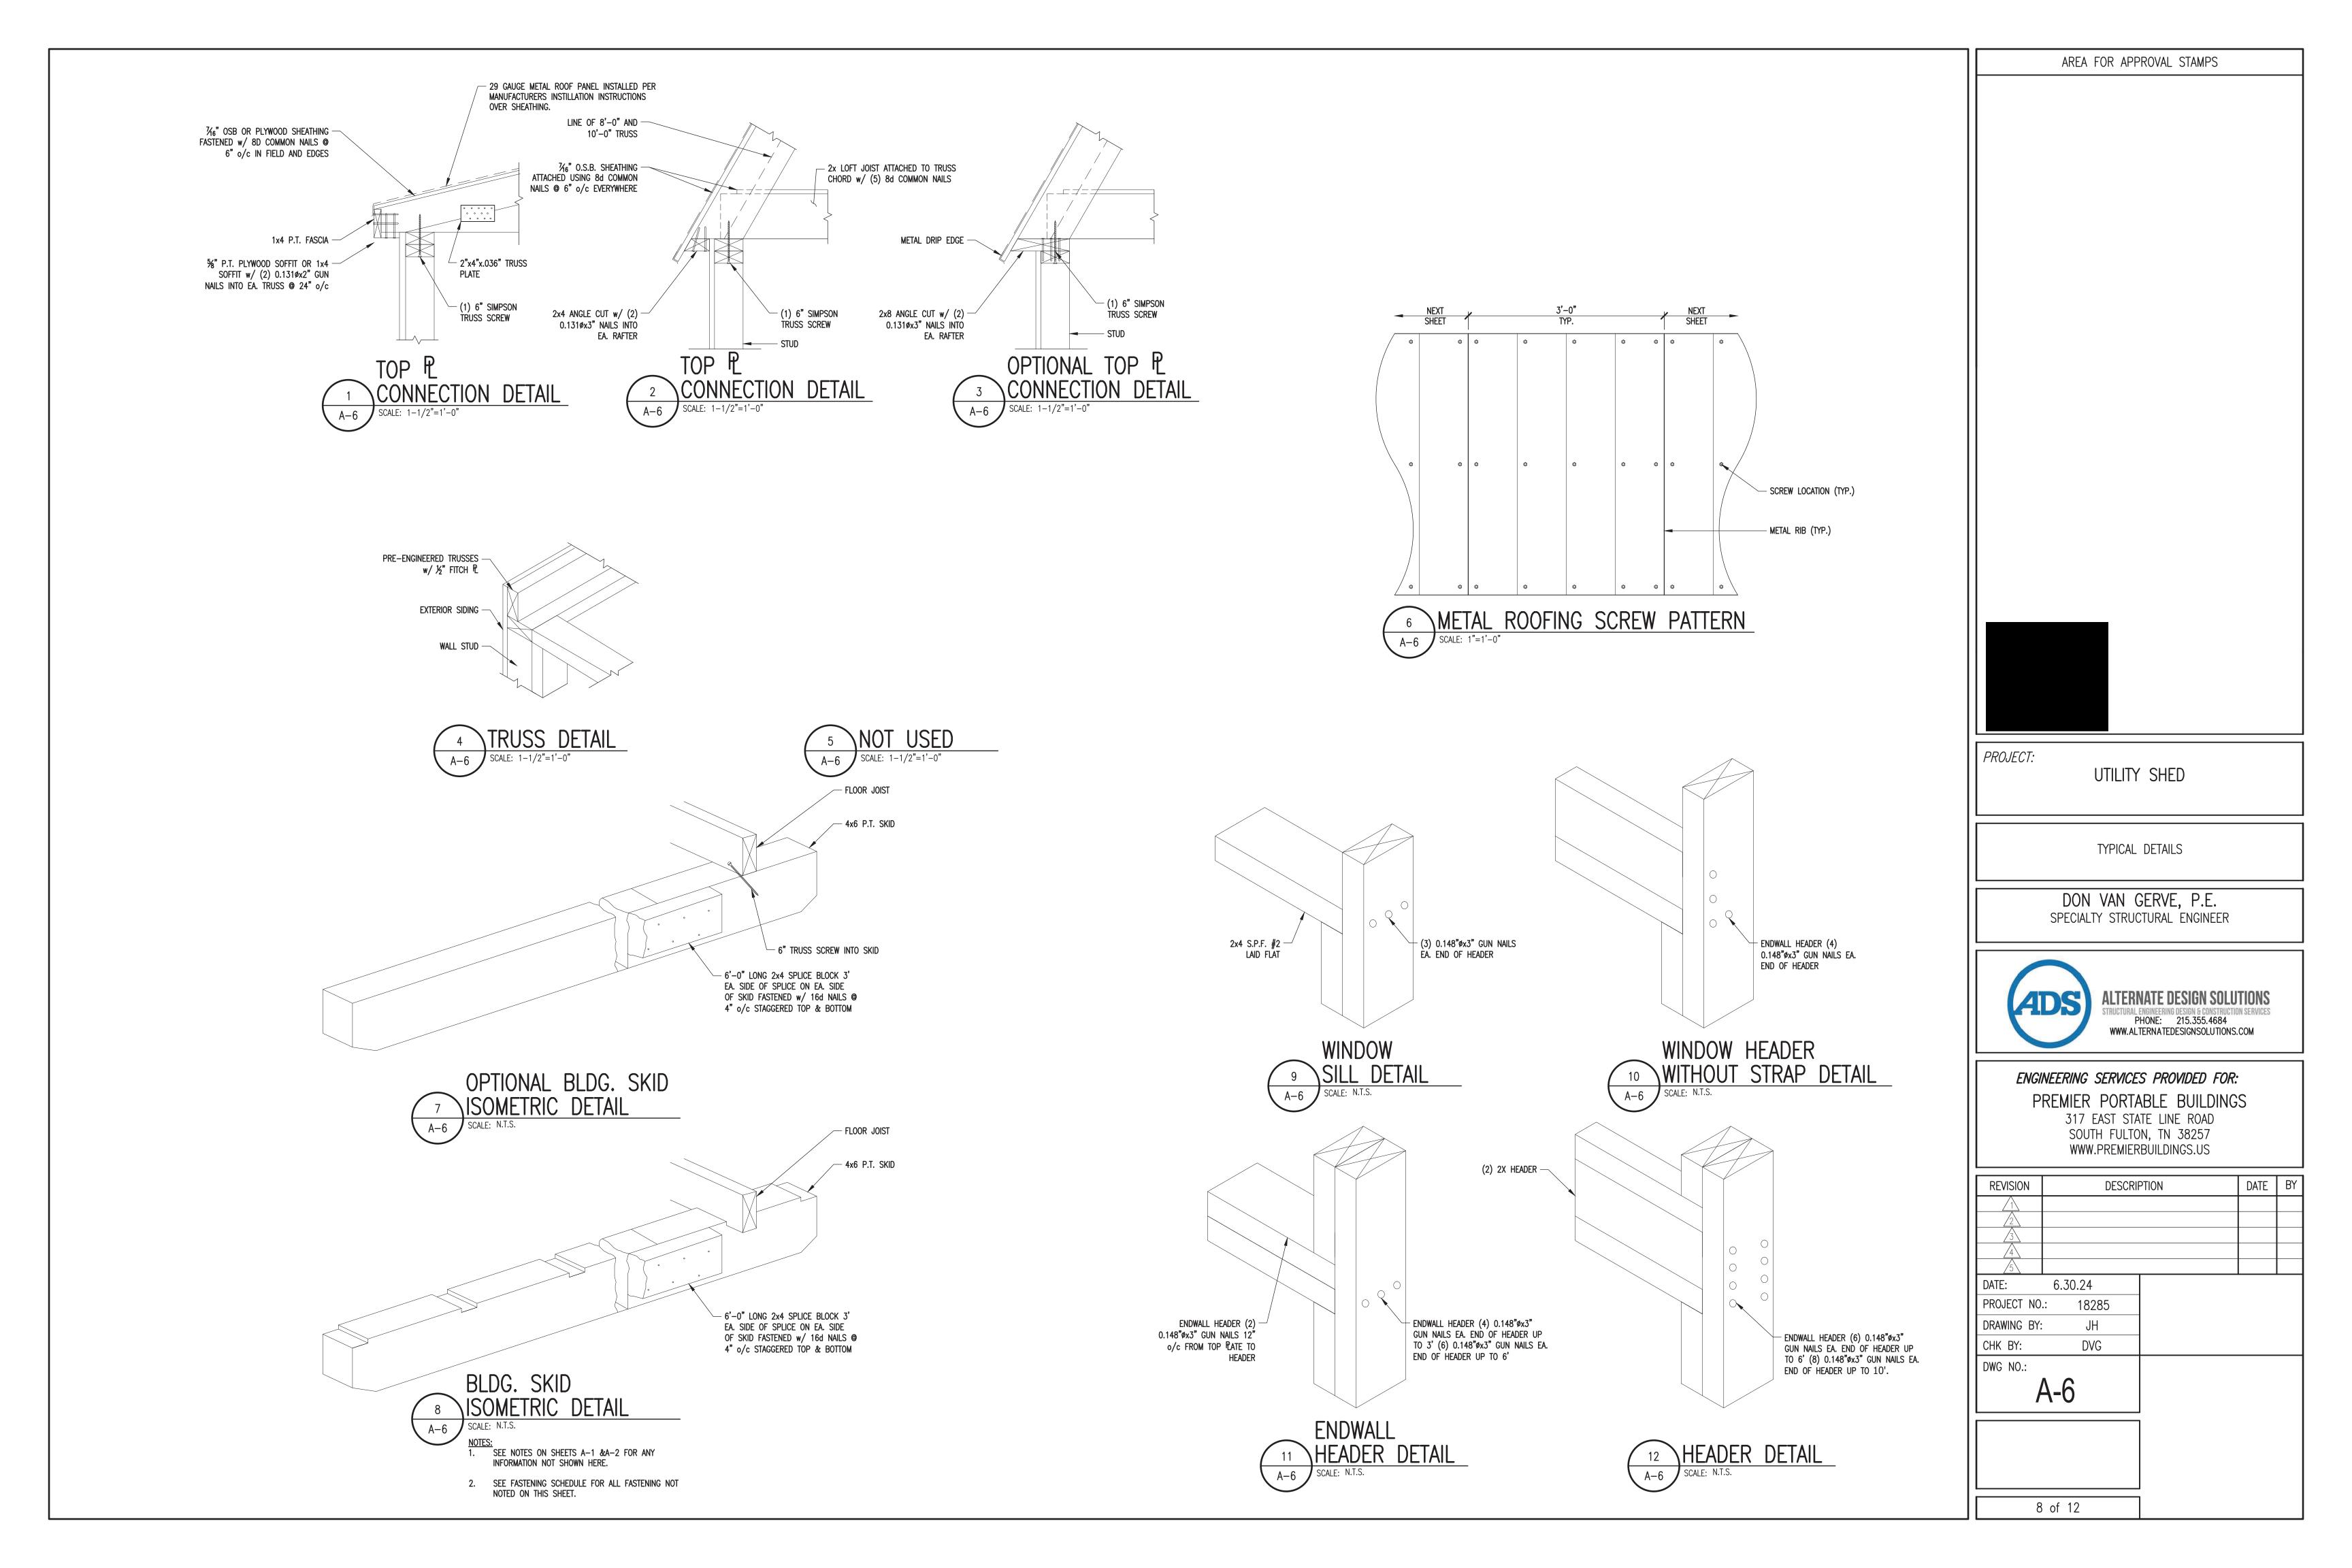

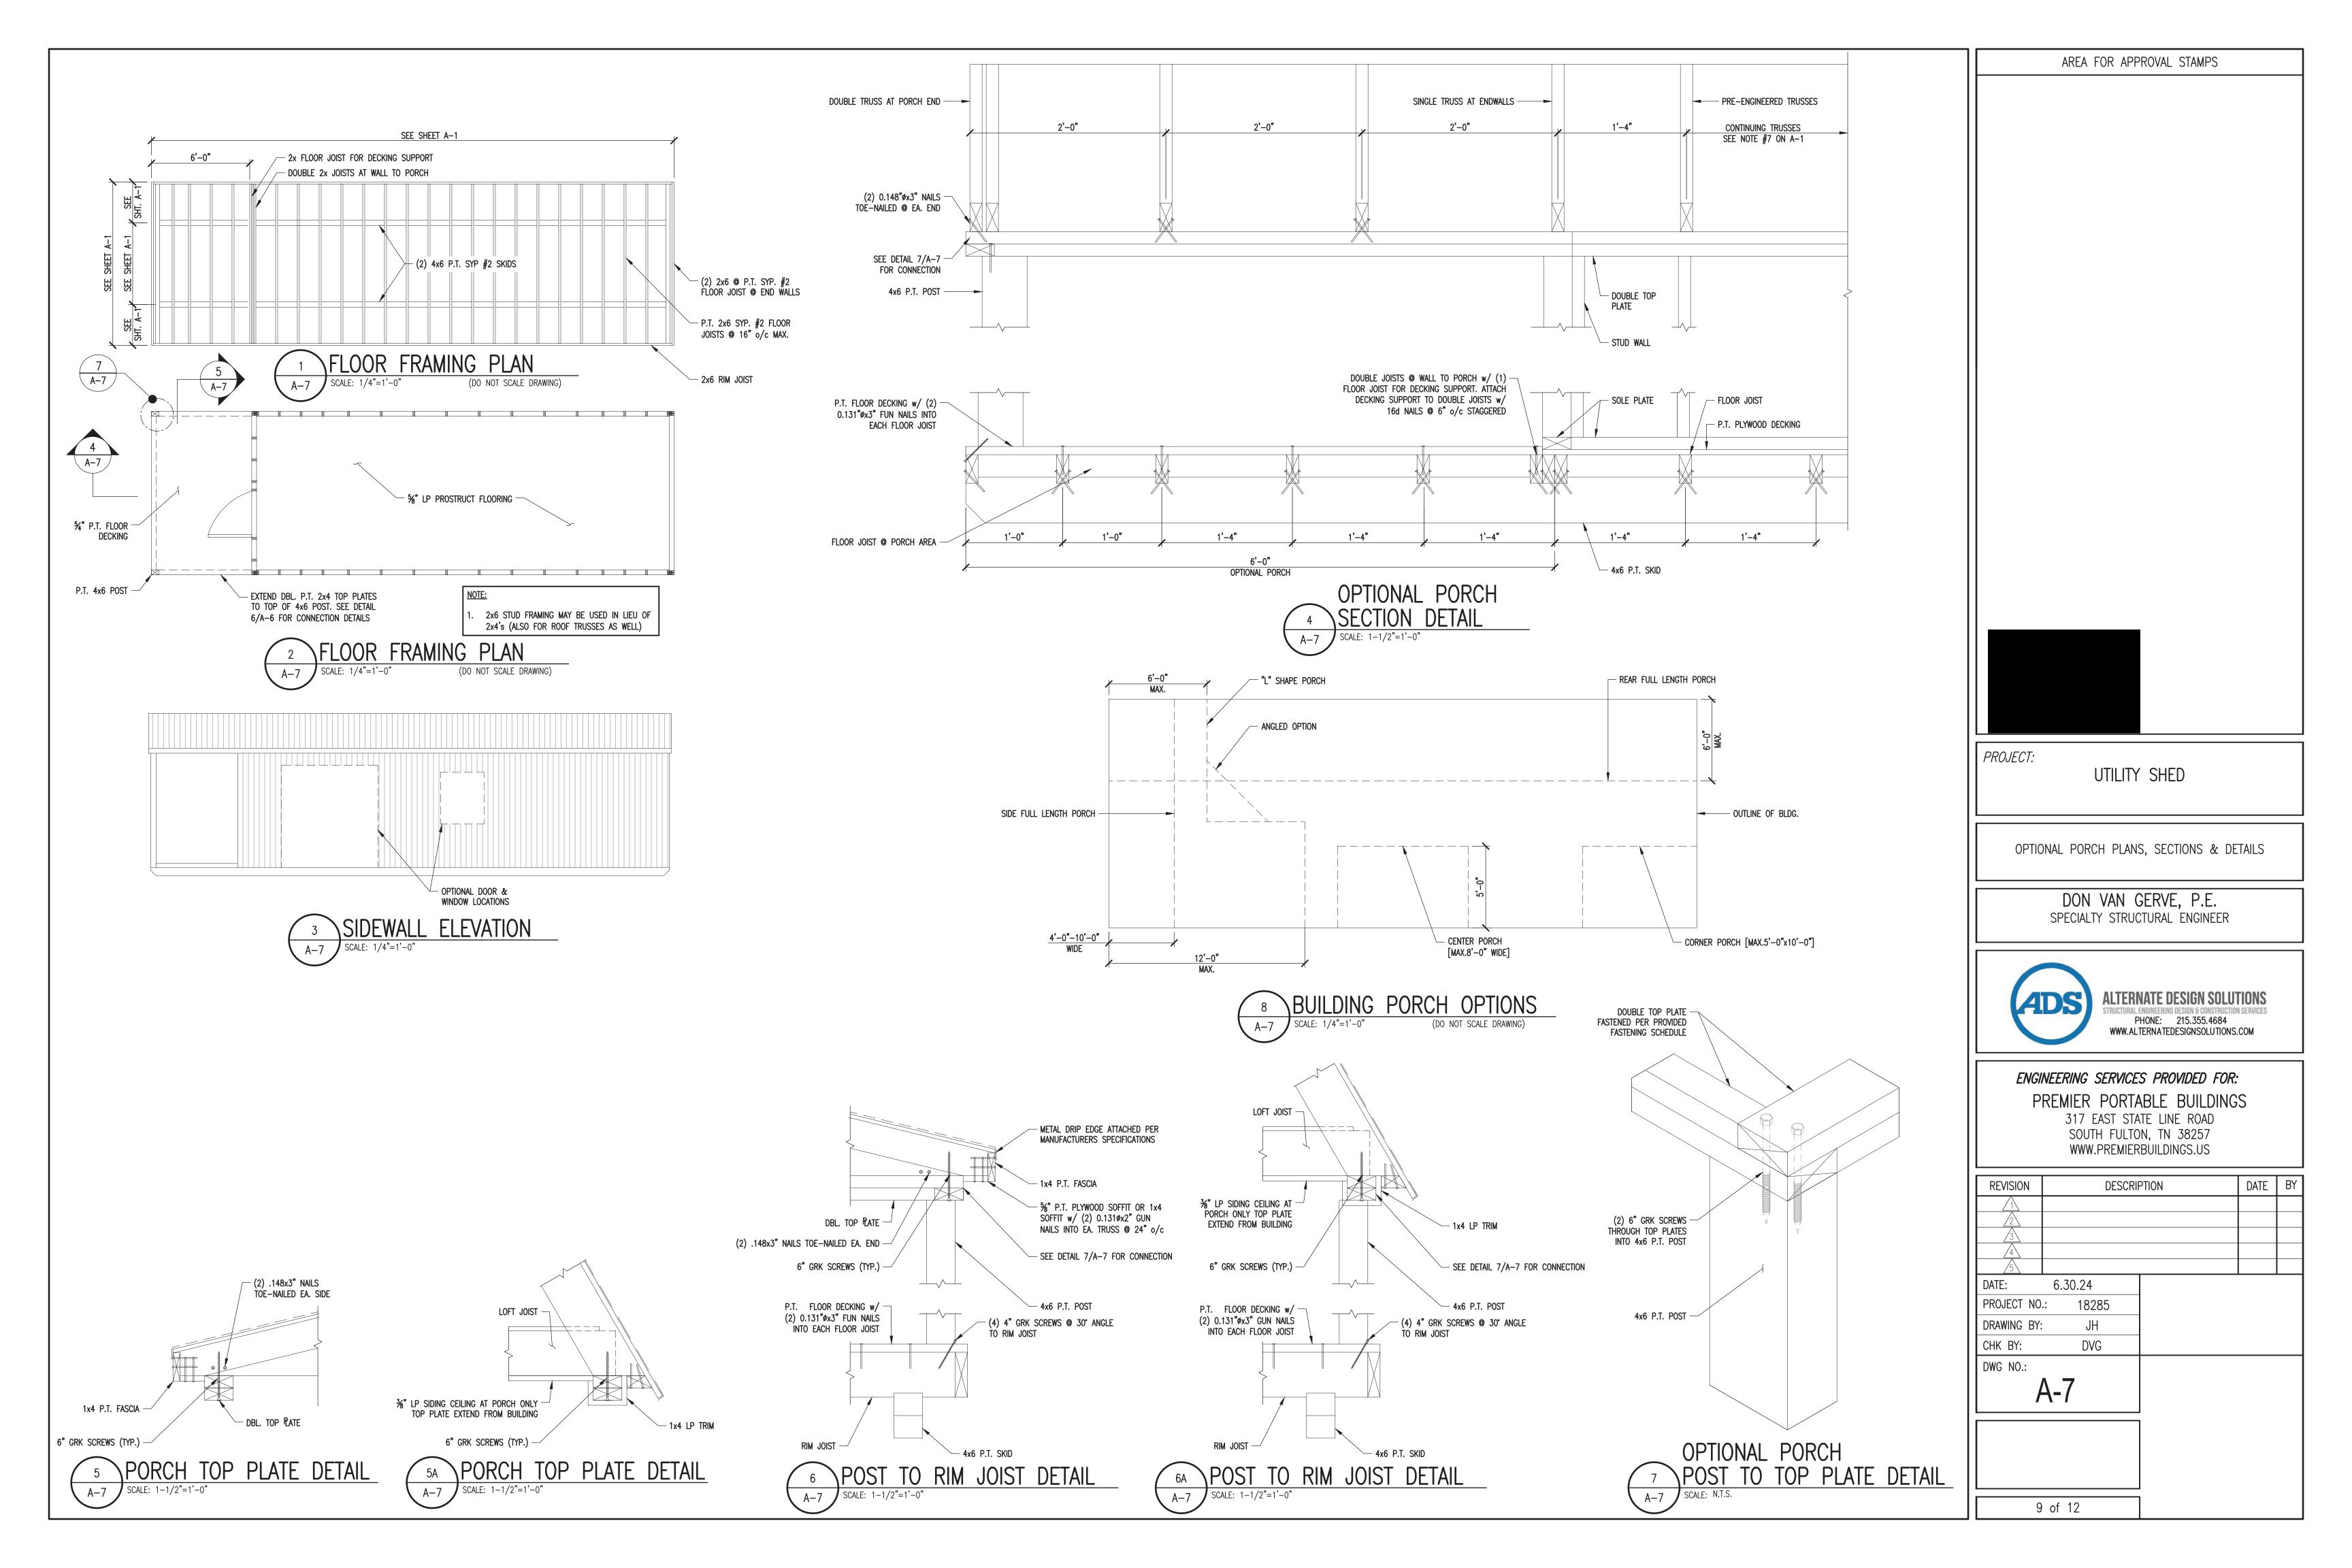

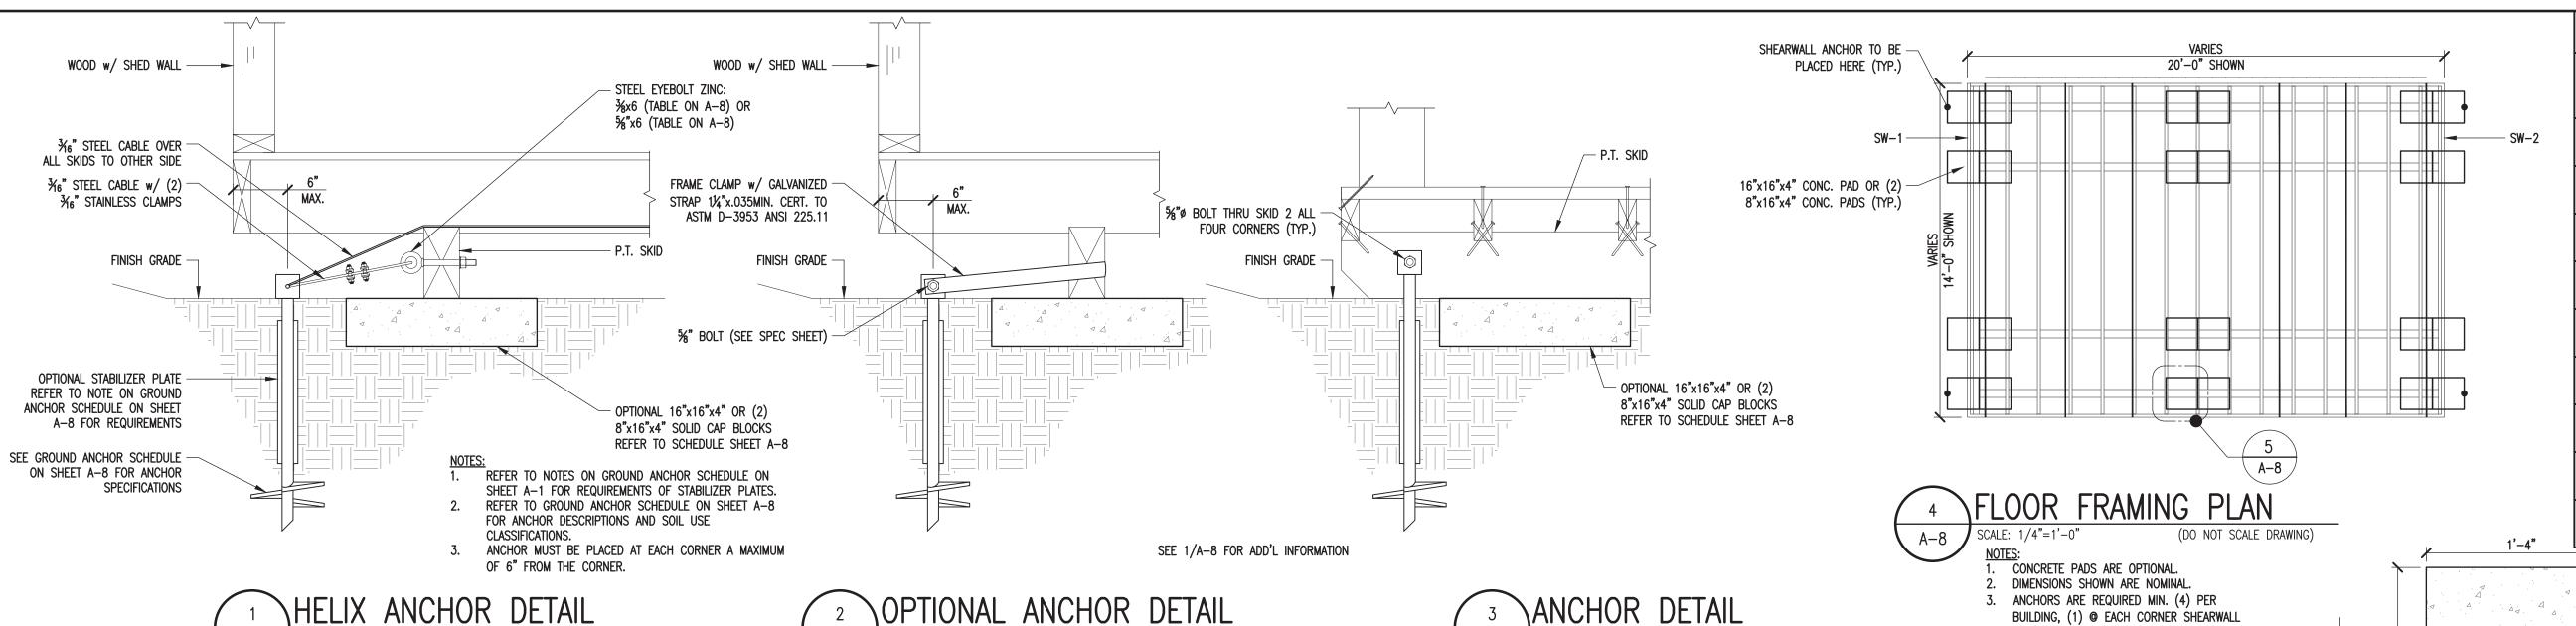

SCALE: 1-1/2"=1'-0"

OPTIONAL PAD SCHEDULE FOR ALL WIND SPEEDS AND EXPOSURES

SCALE: 1-1/2"=1'-0"

BUILDING WIDTH		NUMBER OF PADS BY LENGTH UNDER EACH SKID																	
	10'-0"	12'-0"	14'-0"	<u>16'-0"</u>	<u>18'-0"</u>	20'-0"	<u>22'-0"</u>	<u>24'-0"</u>	<u>26'-0"</u>	<u>28'-0"</u>	30'-0"	<u>32'-0"</u>	<u>34'-0"</u>	<u>36'-0"</u>	<u>38'-0"</u>	40'-0"	<u>50'-0"</u>	<u>60'-0"</u>	
8'-0"	3	3	3	3	3	4	4	4	N/A	N/A	N/A	N/A	N/A	N/A	N/A	N/A	N/A	N/A	
10'-0"	3	3	3	4	4	4	4	5	5	5	5	N/A	N/A	N/A	N/A	N/A	N/A	N/A	
11'-2"	2	2	3	3	3	3	3	3	3	4	4	4	N/A	N/A	N/A	N/A	N/A	N/A	
12'-0"	2	2	3	3	3	3	3	3	4	4	4	4	4	4	N/A	N/A	N/A	N/A	
14'-0"	2	3	3	3	3	3	3	4	4	4	4	4	4	5	5	5	6	7	
16'-0"	2	3	3	3	3	3	3	4	4	4	4	4	5	5	5	5	6	7	

ANCHORING FOR 115 M.P.H. WIND SPEED, EXPOSURE "C" - 3/8" ANCHOR BOLT

BUILDING	NUMBER OF ANCHORS EACH SIDE WALL																			
WIDTH	MAX.	10'-0"	12'-0"	14'-0"	<u>16'-0"</u>	<u>18'-0"</u>	20'-0"	22'-0"	<u>24'-0"</u>	<u>26'-0"</u>	<u>28'-0"</u>	<u>30'-0"</u>	32'-0"	<u>34'-0"</u>	<u>36'-0"</u>	<u>38'-0"</u>	40'-0"	<u>50'-0"</u>	<u>60'-0"</u>	
8'-0"	3.15	4	4	4	5	5	7	7	7	7	7	9	9	9	13	11	12	13	14	
10'-0"	3	4	4	4	5	5	7	7	7	7	7	9	9	9	14	11	12	13	14	
11'-2"	3.98	3	3	3	4	4	6	6	6	6	6	8	8	8	11	10	10	11	12	
12'-0"	4.01	3	3	3	4	4	5	5	5	5	5	8	8	8	10	10	10	10	11	
14'-0"	4.10	3	3	3	4	4	5	5	5	5	5	8	8	8	10	9	9	10	11	
16'-0"	4.18	3	3	3	4	4	5	5	5	5	5	8	8	8	10	9	9	10	11	

ANCHORING FOR 115 M.P.H. WIND SPEED, EXPOSURE "C" - 5/8" ANCHOR BOLT

	<u> </u>																				
BUILDING		NUMBER OF ANCHORS EACH SIDE WALL																			
WIDTH	MAX.	10'-0"	12'-0"	14'-0"	<u>16'-0"</u>	<u>18'-0"</u>	<u>20'-0"</u>	<u>22'-0"</u>	24'-0"	<u>26'-0"</u>	<u>28'-0"</u>	<u>30'-0"</u>	<u>32'-0"</u>	<u>34'-0"</u>	<u>36'-0"</u>	<u>38'-0"</u>	40'-0"	<u>50'-0"</u>	<u>60'-0"</u>		
8'-0"	4.61	4	4	5	5	5	6	6	6	6	6	7	8	8	8	8	8	9	10		
10'-0"	4.30	4	4	5	5	6	6	6	6	6	6	7	8	8	8	8	8	9	10		
11'-2"	5.84	3	4	4	4	5	5	6	6	6	6	7	7	7	7	7	7	8	9		
12'-0"	5.88	3	4	4	4	5	5	5	5	5	5	6	7	7	7	7	7	8	8		
14'-0"	6.01	3	3	4	4	4	5	5	5	5	5	6	6	6	6	6	6	7	8		
16'-0"	6.13	3	3	4	4	4	5	5	5	5	5	6	6	6	6	6	6	7	8		

GROUND ANCHOR SCHEDULE											
MODEL #	PART #	<u>DESCRIPTION</u>	<u>SOIL</u> <u>CLASS</u>								
M12H5/8	59080 / 59081	48" x %" ROD w/ (1) 6" HELIX	4A								
M12H3/4	59085 / 59094	48" x ¾" ROD w/ (1) 6" HELIX	4A								
M1423/4	59128	42" x ¾" ROD w/ (2) 4" HELIX	4A								
M1483/4	59086	48" x ¾" ROD w/ (2) 4" HELIX	4A								
M12H64	59250	36" x 3/4" ROD w/ (1) 4" HELIX & (1) 6" HELIX	4A								
N/A	59065	EYE ANCHOR - 48" X %" w/ (1) 6" HELIX	4A								
N/A	59045	EYE ANCHOR - 48" X 3/4" w/ (1) 6" HELIX	4A								
M607	59099	60" X ¾" w/ (1) 7" HELIX	4B								
N/A	59040	EYE ANCHOR 60" X 3/4" w/ (1) 8" HELIX	4B								
 X											

16x16x4 NOMINAL PAD - 4x6 SKID

BUILDING, (1) @ EACH CORNER SHEARWALL

4. REFER TO SCHEDULES ON SHEET A-8 FOR ANCHOR SPACING & OPTIONAL PAD LOCATION.

5. SPACE OPTIONAL PADS EQUALLY.

(2) 8x8x4 NOMINAL PADS

GENERAL NOTES: 1. THE CONTRACTOR SHALL BE RESPONSIBLE FOR VERIFYING ALL EXISTING

2. THE CONTRACTOR SHALL BE RESPONSIBLE FOR COORDINATING ARCHITECTURAL, STRUCTURAL, MECHANICAL, AND ELECTRICAL DETAIL AND DIMENSIONS, ANY DISCREPANCIES BETWEEN SUCH DETAILS AND DIMENSIONS SHALL BE REPORTED TO THE ENGINEER PRIOR TO PROCEEDING WITH THE WORK.

3. THE CONTRACTOR SHALL BE RESPONSIBLE FOR ERECTION PROCEDURE AND SEQUENCE TO INSURE THE INTEGRITY OF THE BUILDING AND ITS COMPONENT PARTS DURING CONSTRUCTION.

4. THESE PLANS HAVE BEEN PREPARED PER REGULATIONS OF THE 2015 CANADA BUILDING CODE. THE WORK OF ALL CONTRACTORS SHALL COMPLY WITH THE REQUIREMENTS SET FORTH IN THE AFOREMENTIONED CODE. NO DEVIATIONS FROM THE WORK SHOWN OR REASONABLY IMPLIED SHALL BE UNDERTAKEN WITHOUT THE ENGINEERS WRITTEN CONSENT — A COPY OF WHICH WILL BE FILLED WITH THE CONSTRUCTION OFFICIAL.

5. ANY CHANGES TO OR DEVIATIONS FROM THESE DRAWINGS SHALL NOT BE MADE WITHOUT WRITTEN CONSENT FROM THE ENGINEER.

6. THESE DRAWINGS ARE THE PROPERTY OF THE ENGINEER AND SHALL NOT BE USEI WITHOUT HIS CONSENT. DRAWINGS SHALL NOT BE USED FOR ISSUE OF BUILDING PERMIT UNLESS SIGNED AND SEALED BY THE ENGINEER.

7. THE OWNER AND CONTRACTOR SHALL HOLD HARMLESS THE ENGINEER FROM AND AGAINST ALL LIABILITY CLAIMS, DAMAGES, LOSSES AND EXPENSES INCLUDING LEGAL FEES ARISING OUT OF OR RESULTING FROM ERRORS OR OMISSIONS IN THE PERFORMANCE OF THE WORK BY THE CONTRACTOR. ALL WORK AND MATERIAL SHALL MEET THE REQUIREMENTS OF ALL LOCAL AND STATE BUILDING CODES. THE DRAWING SHOW THE GENERAL ARRANGEMENTS AND EXTENT OF THE WORK. AS THE WORK PROGRESSES, THE OWNER AND THE CONTRACTOR, AT NO EXTRA COSTS, SHALL MAKE MODIFICATIONS TO MAKE THE PARTS ALIGN.

8. CONTRACTORS SHALL CHECK AND VERIFY ALL PLAN DIMENSIONS AND CONDITIONS REVISION BEFORE PROCEEDING CONSTRUCTION. HE SHALL REPORT ANY DISCREPANCIES TO THE ENGINEER FOR CORRECTION PRIOR TO BEGINNING ANY WORK. THE DISCOVERY OF DISCREPANCIES AFTER THE BEGINNING OF WORK WILL BE EVIDENCE OF FAULTY WORK AND SHALL BE THE RESPONSIBILITY OF THE CONTRACTOR. DO NOT SCALE DRAWINGS. ALL WRITTEN DIMENSIONS GOVERN.


9. THE CONTRACTOR FOR THIS PROJECT SHALL INCLUDE ALL MATERIALS AND LABOR REQUIRED TO COMPLETE THE TOTAL PROJECT. THE CONTRACTOR SHALL FURNISH AND PAY FOR ALL MATERIALS, TOOLS, EQUIPMENT, LABOR, MACHINERY, TRANSPORTATION, HEAT, WATER, UTILITIES, AND ALL OTHER FACILITIES AND SERVICES REQUIRED FOR THE SAFE AND PROPER EXECUTION AND COMPLETION OF THE WORK. THE ENGINEER SHALL BE THE INTERPRETER OF THE CONTRACT

10. THE DOCUMENTS SHOWN AN OVERVIEW OF THE WORK REQUIRED UNDER THIS CONTRACT AND RELATED REQUIREMENTS AND CONDITIONS THAT WILL IMPACT THE PROJECT. ALL DRAWINGS ARE COMPLIMENTARY. THE DRAWINGS GENERALLY SHOW THE INTENT OF THE OVERALL COMPLEXITY AND CONCEPTS OF THE PROJECT, AND | DWG NO.: DO NOT NECESSARILY SHOW ALL DETAILS AND CONDITIONS.

11. ALL NEW INTERIOR CONCRETE SLABS AND FOUNDATION WALLS AND FOOTING SHALL HAVE SOLID POISONING UNDER NEW WORK AND SHALL BE INSTALLED BY A LICENSED CONTRACTOR. ALL WORK SHALL BE COMPLETED IN ACCORDANCE WITH ALL STATE AND DEPARTMENT OF AGRICULTURE, STRUCTURAL PEST CONTROL DIVISION REGULATIONS. RULES. DEFINITIONS AND REQUIREMENTS.

12. THE CONTRACTOR SHALL BE RESPONSIBLE FOR VERIFYING AND MAINTAINING ALL EXITING SETBACKS, EASEMENTS, AND ANY DEED RESTRICTIONS.

13. THE GENERAL CONTRACTOR SHALL BE RESPONSIBLE FOR FINAL CLEANUP AND SHALL INCLUDE THE SITE, AND THE BUILDING. THE ENTIRE PROJECT SHALL BE LEFT IN A NEW, CLEAN CONDITION.

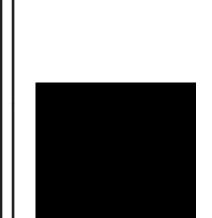

PROJECT:

UTILITY SHED

FASTENING SCHEDULE / WIND LOADING

DON VAN GERVE, P.E. SPECIALTY STRUCTURAL ENGINEER



ALTERNATE DESIGN SOLUTIONS STRUCTURAL ENGINEERING DESIGN & CONSTRUCTION SERVICES PHONE: 215.355.4684 WWW.ALTERNATEDESIGNSOLUTIONS.COM

ENGINEERING SERVICES PROVIDED FOR: PREMIER PORTABLE BUILDINGS 317 EAST STATE LINE ROAD SOUTH FULTON, TN 38257 WWW.PREMIERBUILDINGS.US

١	REVISION	DESCRI	PTION	DATE	BY
	2				
١	3				
ı	4				
ı	5				
ı	DATE:	6.30.24		-	

PROJECT NO.: 18285 DRAWING BY: CHK BY: DVG

10 of 12

VIRAG HARENDRARAY BHACHECH (P.Eng.) "PREMVILLA" 78-SLEIGHTHOLME CRESCENT BRAMPTON ON. L6P-3E7 TEL/FAX: 905-794-3385.

Premier Portable Buildings


Date: 18TH April -2023


PROJECT: Use of SPF - Structural

As per Wood Design Manual, the specified strengths & Modulus of Elasticity are substantially higher for SPF – Structural wood, so they are suitable to use as a Structural floor Joists and skids.







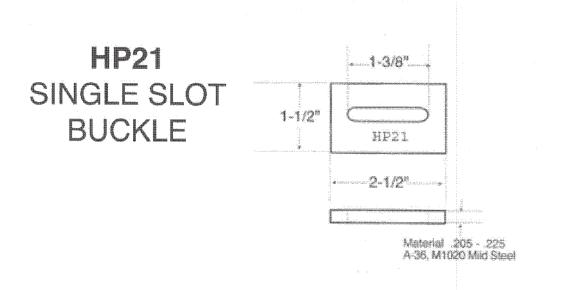


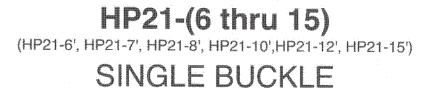



W/STRAP

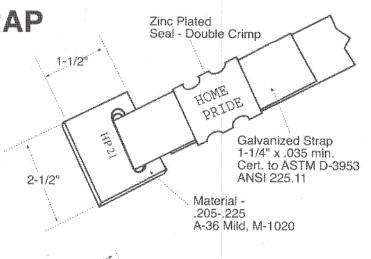


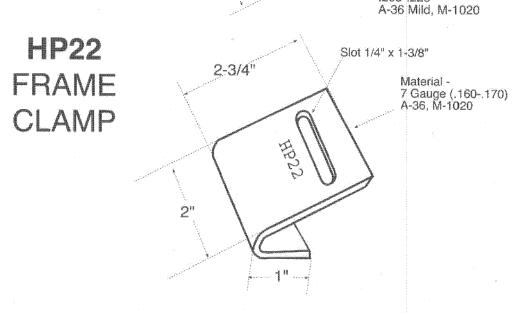

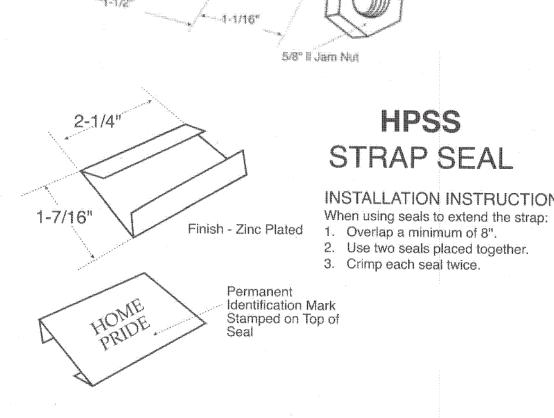

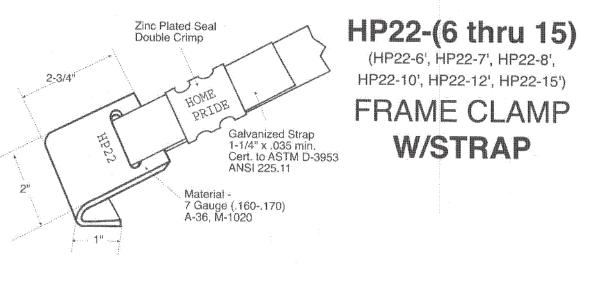

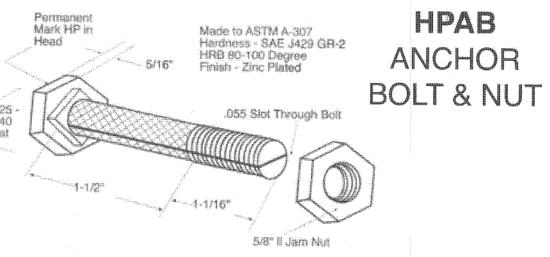

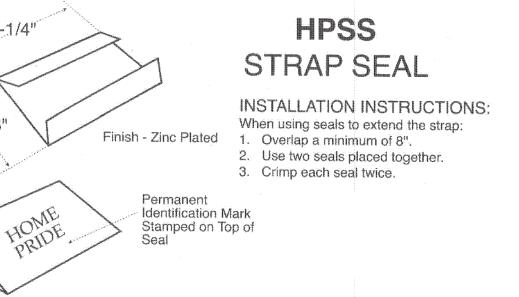

PROJECT:

UTILITY SHED

AREA FOR APPROVAL STAMPS

PRODUCT CUT SHEETS


DON VAN GERVE, P.E. SPECIALTY STRUCTURAL ENGINEER




ENGINEERING SERVICES PROVIDED FOR: PREMIER PORTABLE BUILDINGS 317 EAST STATE LINE ROAD SOUTH FULTON, TN 38257 WWW.PREMIERBUILDINGS.US

Ш	REVISION	DESCRI	PTION	DATE	BY
Ш					
Ш	<u>/2</u>				
Ш	<u>/</u> 3\				
Ш	<u>/4\</u> /5\				
	DATE:	6.30.24			
Ш	PROJECT NO	: 18285			
Ш	DRAWING BY:	JH			
Ш	CHK BY:	DVG			
Ш	DWG NO.:				
	<i>F</i>	4-9			
]		
Ш					

11 of 12

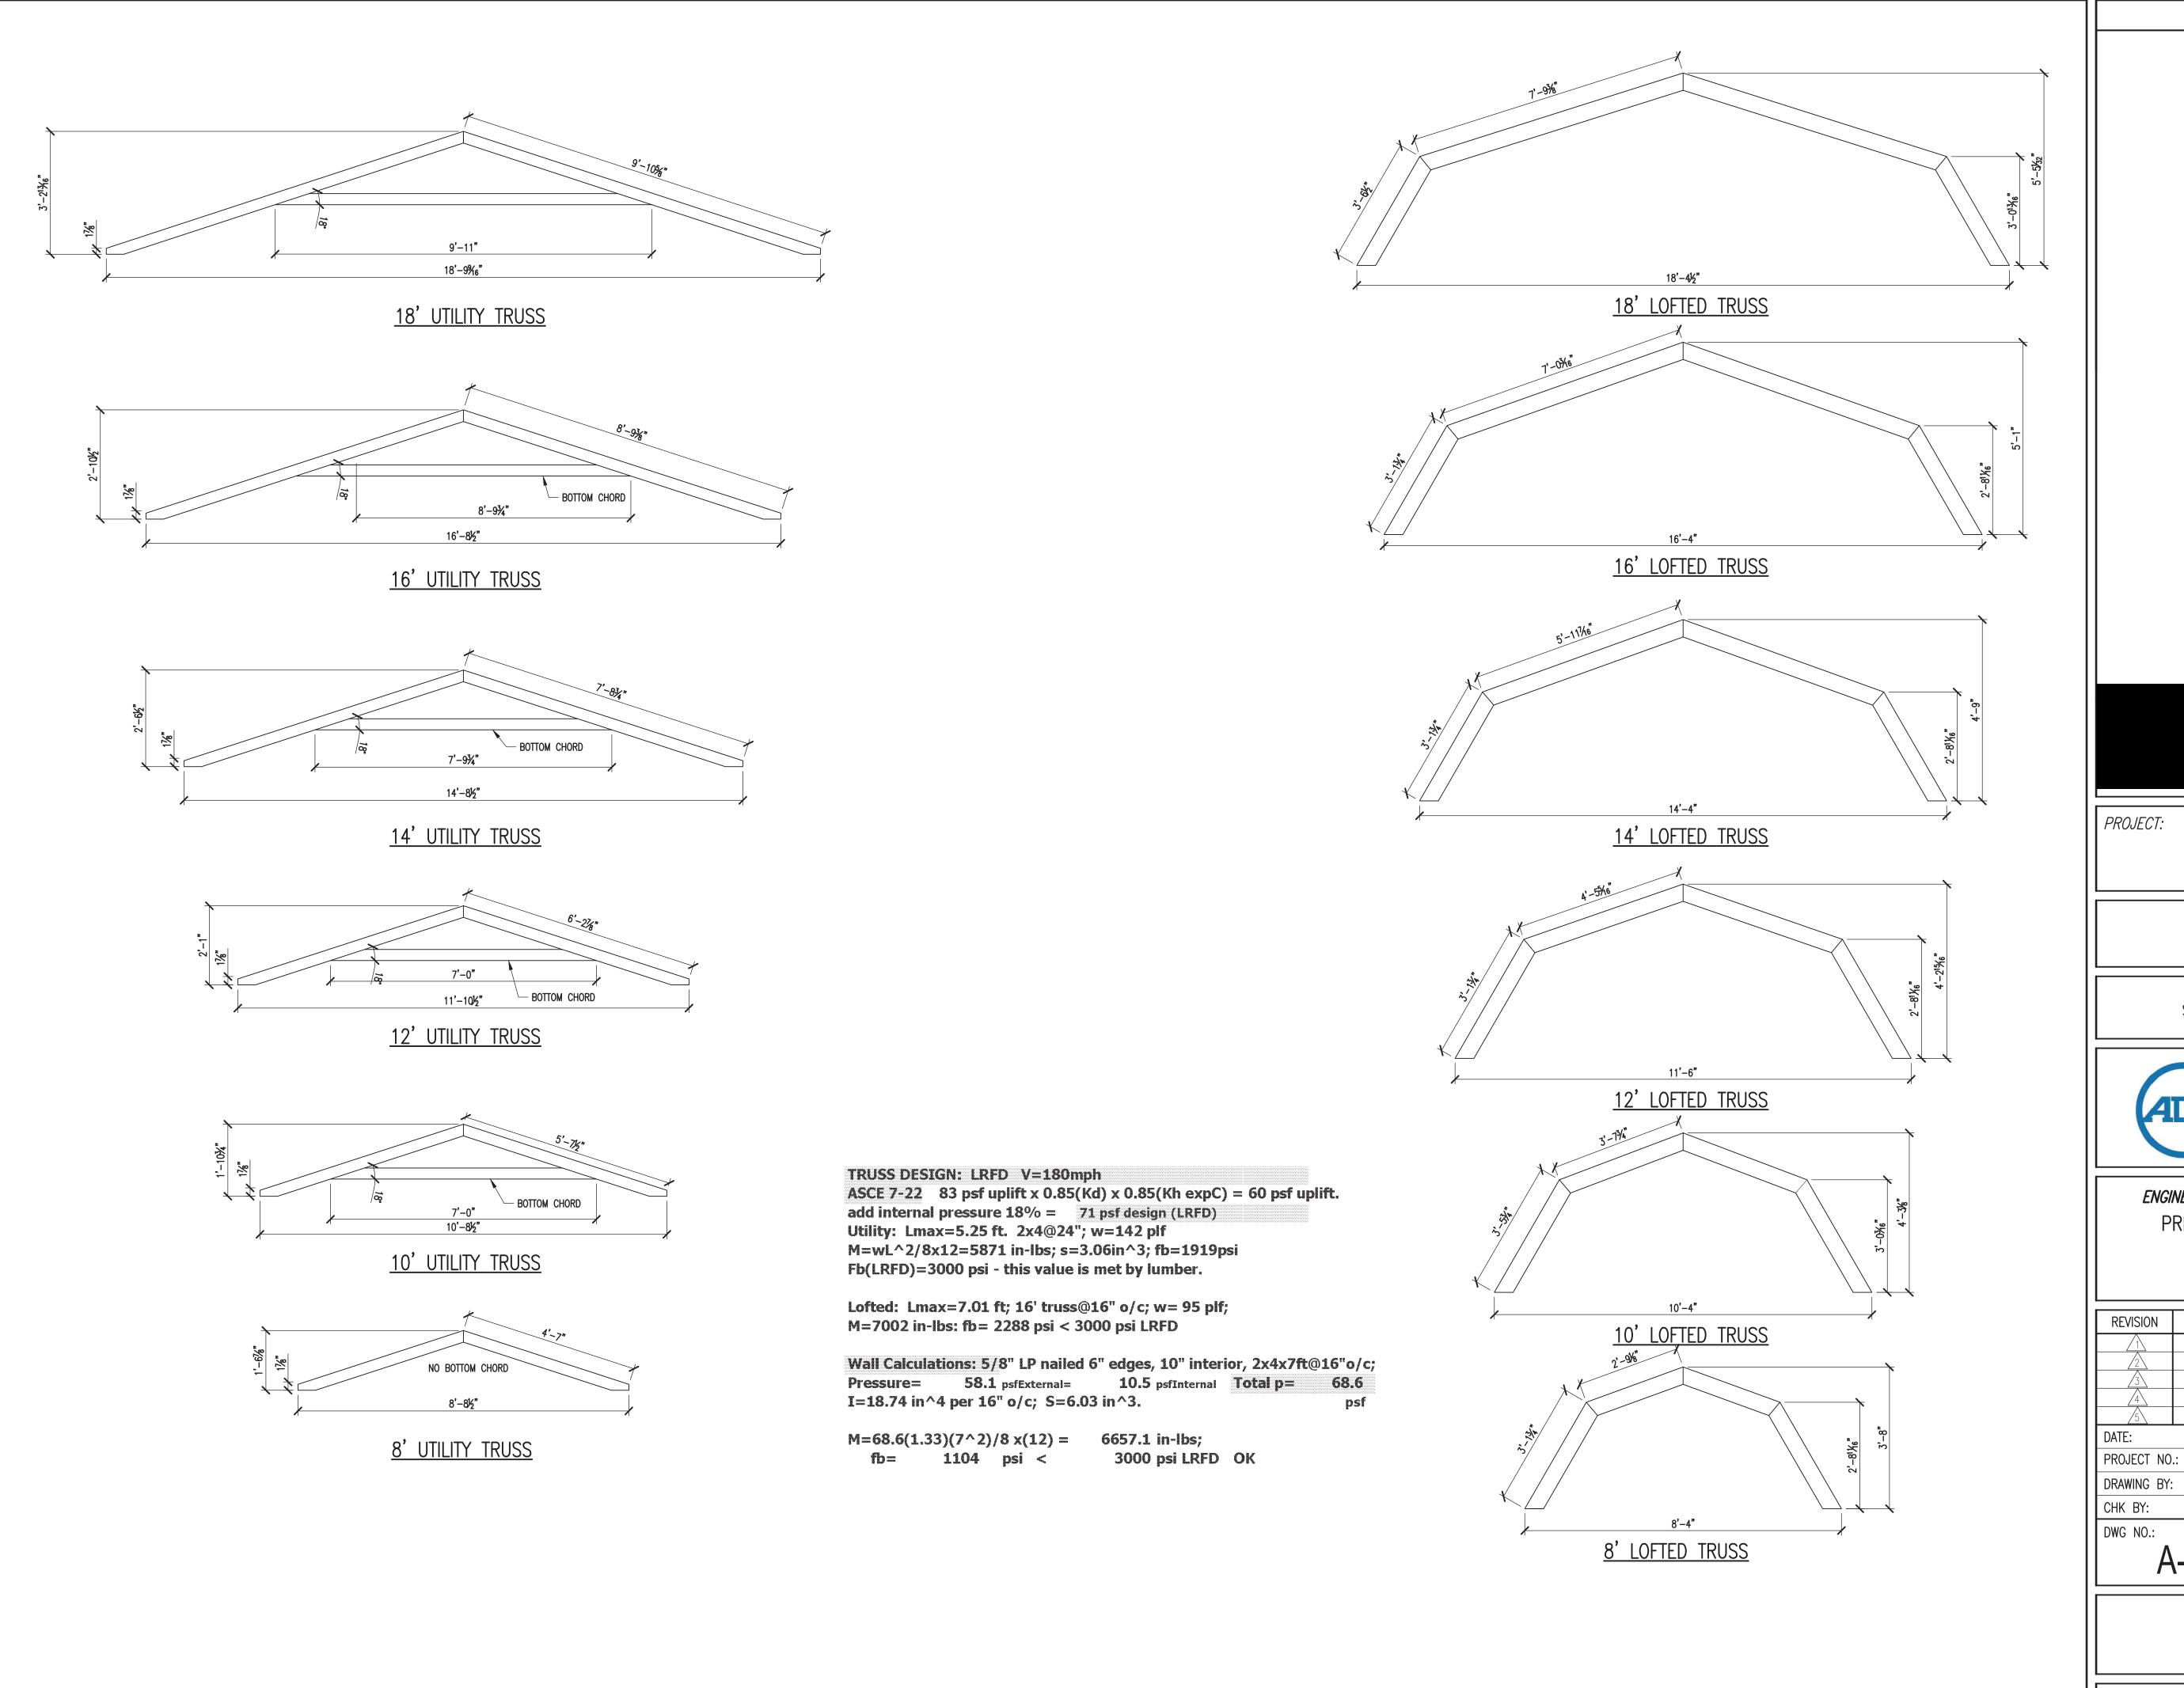

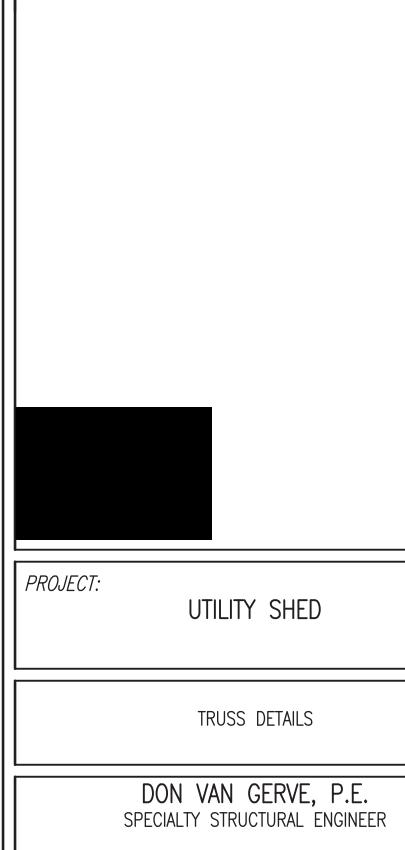

ALTERNATE DESIGN SOLUTIONS
STRUCTURAL ENGINEERING DESIGN & CONSTRUCTION SERVICES
PHONE: 215.355.4684
WWW.ALTERNATEDESIGNSOLUTIONS.COM

DATE BY

ENGINEERING SERVICES PROVIDED FOR:

REVISION

DATE:

PREMIER PORTABLE BUILDINGS

317 EAST STATE LINE ROAD SOUTH FULTON, TN 38257 WWW.PREMIERBUILDINGS.US

DESCRIPTION

6.30.24

A-10

12 of 12

18285

DVG

AREA FOR APPROVAL STAMPS