

Affidavit

Township of Puslinch 7404 Wellington County Rd 34, Puslinch, ON NOB 2J0 (519) 763-1226

Cloudpermit application number CA-3523001-P-2025-47

Applicant, Payer			
Last name Waugh	First name Kevin		Corporation or partnership Fine line structures
Street address	Unit number		Lot / Con.
Municipality	Province Ontario		Postal code
Other phone		Mobile pho	ne
Fax		Email kevin@finel	linestructures.com

Property owner				
Last name Seymour	First name Cailey		Corporation or partnership	
Street address 4424 Victoria Rd South	Unit number		Lot / Con.	
Municipality puslinch	Province ontario		Postal code N0B2J0	
Other phone		Mobile phone	Mobile phone	
Fax		Email		

Subject Land Information				
Address	Legal description	Roll number		
4424 VICTORIA RD S (Primary)	CON 8 N PT LOT 23 RP;61R10326 PART 2	2301000006018000000		

Sworn Declaration of Applicant		
Complete in the presence of a Commission	er for taking affidavits	
545/06 and provided by the Applicant is ac application is accurate, and I make this sole	nnly declare that the information required un curate and that the information contained in emn declaration conscientiously believing it th and by virtue of the Canada Evidence Act	the documents that accompany this to be true, and knowing that it is of the
Signature of Applicant (sign in the presence	e of a Commissioner for taking affidavits)	
Signature of Commissioner for taking affidavits	Municipality Township OF Pustinch	Day, month, year 11 / JUNE / 2025
Place an imprint of your stamp below	•	
	Monika Alyse Famcombe, a Commissioned Province of Ontario, for the Corporation of Township of Puslinch. Expires February 14, 2027.	

Affidavit and signatures

Applicant

The Kevin Waugh, Applicant is required to agree to erect and maintain a sign on the subject lands and to permit Township employees/representatives to enter the lands for site visits. The sign will be provided to the applicant for posting on the property by Township planning staff along with instructions on how and where to post the sign. The sign must be posted at least 10 days prior to the Committee of Adjustment meeting date for the application and must remain on the property until the 20 day appeal period is expired.

Notice with respect to collection of personal information

Personal information on this form is collected under the authority of the Planning Act. The information is used for the purpose of processing this application and administering the legislation and is maintained in accordance with the Municipal Freedom of Information and Protection of Privacy Act. Questions regarding the collection of this information may be directed to the Township Clerk's office.

The Township of Puslinch is committed to providing accessible formats and communication supports for people with a disability. If another format would work better for you, please contact the Township Clerk's office for assistance.

Z

Digitally signed on 2025-06-11, 12:21:55 p.m. EDT by Kevin Waugh.

Send correspondence to					
Send correspondence to		Please provide the name of Other			
Owner(s) Agent Others					
Who to send the Invoice to					
Owner 🗹 Agent		Other			
Provide a description of the "el	ntire" prope	erty			
Concession		Lot	Registered Plan Number		d Plan Number
8 N PT		22			
Area in Hectares		Area in Acres	Depth is		Meters
3.73				300m	
Depth in Feet	Frontage	in Meters	Frontage in Feet		Width of road allowance (if
	92m				known)
Danas for Application				.a.	
Reason for Application			RUME BUT ME		
Please indicate the Section of th	_		•		
Section 45(1) relates to a ch				•	
Section 45(2) relates to a ch	nange to or	expansion of an existir	ng legal non- conformi	ng use	
What is the nature and extent of the relief that is being applied for?			Why is it not possible law?	to comply	with the provisions of the by-
Looking for relief From Maximum accessory structure cover of			Additional storage is	required on	site for the owner and so an
600sqm. seeking sqm (total) to provide a new 50x30 garage		additional building is	need.		
What is the current Official Plan	and zoning	g status?			
Official Plan Designation			Zoning Designation		
Building 1500 sqft garge for main	n property u	se	Agricultural		
What is the access to the subjec	t property?				
Provincial Continually Seasonally maintained municipal road municipal road					
Other	ally maintained oad				
What is the name of the road or s the subject property? Victoria Road South	street that p	rovides access to	docking facilities used	d or to be us	describe the parking and sed and the approximate he subject land to the nearest

Existing and Proposed Service						
Indicate the applicable water supply an	d sewage disposal:					
Private Well			Existing	Proposed		
Communal Water			Existing	Proposed		
Provincial Water Taking Permit			Existing	Proposed		
Private Septic			Existing	Proposed		
Communal Septic			Existing	Proposed		
Other Provincial Waste Water System			Existing	Proposed		
How is storm drainage provided? * ☐ Storm Sewers	✓ Swales					
Existing Subject and Abutting Property La	ınd Uses, Buildings ar	d their Locations				
What is the existing use of the subject property? Agricultural		What is the existing use of the abutting properties? Agricultural				
Provide the following details for all existing	g buildings on the sul	oject land				
Main Building Height in Meters 1.6725	Main Building Heigh 18	t in Feet	Percentage Lot Co	overage in Meters		
Percentage Lot Coverage in Feet 1.20	Number of Parking 9	Spaces	Number of Loadin	Number of Loading Spaces 0		
Number of Floors 1	Total Floor Area in Square Meters 447.60		Total Floor Area in 4818	Total Floor Area in Square Feet 4818		
Ground Floor Area (Exclude Basement) in S 447.60			Ground Floor Area (Exclude Basement) in Square Fee 4818			
Provide the following details for all building	gs proposed for the s	ubject land	Magnist Vy			
Main Building Height in Meters 5.8	Main Building Height in Feet 19		Percentage Lot Coverage in Meters 0.4			
Percentage Lot Coverage in Feet 0.4	Number of Parking Spaces 0		Number of Loading Spaces 0			
Number of Floors 1	Total Floor Area in So	quare Meters	Total Floor Area in Square Feet 1500			
Ground Floor Area (Exclude Basement) in S 139.40	quare Meters	Ground Floor Area	Ground Floor Area (Exclude Basement) in Square Fee			

What is the location of all buildings existing for lines)	g and proposed for th	e subject property? (s	specify distances from front, rear and side		
Front Yard in Meters 19.5	Front Yard in Feet 64		Rear Yard in Meters 260		
Rear Yard in Feet 853	Side Yard (interior) in Meters 40		Side Yard (interior) in Feet 132		
Side Yard (Exterior) in Meters 40	•		Side Yard (Exterior) in Feet 132		
What are the dates of acquisition and cons	struction of subject pr	operty and building p	roperty		
Date of acquisition of subject property 2022	Date of construction of buildings property 2012		How long have the existing uses continued on the subject property? 3 years		
Has the owner previously applied for relief in respect of the subject property?					
☐ Yes ☑ No					
Other Related Planning Applications					
Planning Application: Official Plan Amendme	ent	Planning Application: Zoning By-Law Amendment			
Yes V No		☐ Yes ☑ No			
Planning Application: Plan of Subdivision		Planning Application: Consent (Severance)			
☐ Yes ✔ No		☐ Yes ✔ No			
Planning Application: Site Plan		Planning Application: Minor Variance			
☐ Yes 🗹 No		☐ Yes ✔ No			
Minor Variance Application must be commi	issioned				
Please confirm the following					
I understand that prior to the Minor Variation owners or the agent responsible for the	ance Application being application.	deemed complete it n	nust be commissioned by all registered		

GENERAL

- DESIGN & CONSTRUCTION OF ALL WORK ON THIS PROJECT SHALL CONFORM TO THE LATEST EDITION
- NATIONAL BUILDING CODE
- ONTARIO BUILDING CODE
- LOCAL REGULATIONS OHSA REGULATIONS
- THE STRUCTURAL ENGINEERING REVIEW BY WADDELL ENGINEERING LTD (WEL) IS FOR THE STRUCTURAL ITEMS NOTED ON THE STAMPED DRAWINGS FOR WHICH THERE ARE NO ONTARIO BUILDING CODE (OBC) PART 9 PROVISIONS.
- THE SEALED DRAWINGS ARE ONLY FOR USE BY THE PARTY WITH WHOM WEL HAS ENTERED INTO A CONTRACT (THE CLIENT) AND ARE NOT TO BE USED BY OTHERS.
- WEL'S REVIÈW IS BASED ON THE INFORMATION PROVIDED BY THE CLIENT AT THE TIME OF OUR REVIEW. WEL IS NOT RESPONSIBLE FOR ANY ERRORS OR OMISSIONS FROM THIS INFORMATION. IT IS THE CLIENT'S RESPONSIBILITY TO INFORM US OF ANY CHANGES. ADDITIONS OR CORRECTIONS REQUIRED ON OUR DRAWINGS.
- THIS SPECIFICATION SHEET IS TO SUPPLEMENT THE STAMPED DRAWINGS AND OBC PART 9 REQUIREMENTS. PLEASE CONTACT THE LOCAL BUILDING DEPARTMENT OR WEL, IF FURTHER CLARIFICATION IS REQUIRED.
- WEL ASSUMES THAT ALL REQUIRED INSPECTIONS WILL BE DONE BY THE LOCAL BUILDING DEPARTMENT. IF WEL IS REQUIRED TO PERFORM AN INSPECTION, CALL (519) 267-6789. ALLOW 48 HOURS NOTICE FOR ALL INSPECTIONS.
- NO CHANGES SHALL BE MADE WITHOUT THE ENGINEER'S APPROVAL
- HE CLIENT (CONTRACTOR / OWNER) SHALL CHECK AND VERIFY ALL SITE CONDITIONS AND MEASUREMENTS, AND IMMEDIATELY REPORT ANY DISCREPANCIES TO THE ENGINEER, WHICH MAY ADVERSELY AFFECT THE PROPER COMPLETION OF THE JOB BEFORE PROCEEDING WITH THE WORK.
- THE CLIENT (CONTRACTOR / OWNER) IS RESPONSIBLE FOR COORDINATING AND VERIFYING ALL DIMENSIONS SHOWN ON ALL WEL DRAWINGS WITH ALL OTHER RELEVANT DOCUMENTS AND/OR DRAWINGS (DIMENSIONS SHOWN HEREIN ARE <u>FOR REFERENCE ONLY AND REQUIRE VERIFICATION</u>).

DESIGN LOADS

1. DESIGN LOADS UNFACTORED UNLESS NOTED OTHERWISE.

= 0.29 kPa (6 psf) (ROOF RAFTERS / JOISTS OR TRUSS TOP CHORDS) = Cb x Ss + 0.4 kPa; NOT LESS THAN 1 kPa (20.9 psf), AS PER OBC 9.4.2.2.

Cb = 0.55 kPa FOR ROOF WIDTH > 4.3m

Cb = 0.45 kPa FOR ROOF WIDTH <= 4.3m

Ss = 1-IN-50 GROUND SNOW LOAD in kPa

ATTIC OR ROOF SPACE WITH LIMITED ACCESSIBILITY (CEILING JOISTS/TRUSS BOTTOM CHORDS), AS PER OBC 9.4.2.4.(1) TOTAL SPECIFIED LOAD = 0.35 kPa (7.3 psf)

ACCESSIBLE ATTIC = SEE FLOOR LOADING BELOW

FLOOR DESIGN LOADS

= 0.57 kPa (12 psf) DEAD LOAD

= 1.92 kPa (40 psf) (TYP. U.N.O.)

ACCESSIBLE EXTERIOR PLATFORMS, AS PER OBC 9.4.2.3.:

= GREATER OF 1.92 kPa (40 psf) OR SNOW LOAD

GUARD LOADS: AS PER OBC 2012 4.1.5.14.(1).

MATERIALS

1. MATERIALS SHALL CONFORM TO THE FOLLOWING REQUIREMENTS U.N.O. ON THE STAMPED DRAWINGS:

CONCRETE REINFORCING STEEL

LUMBER & WOOD PRODUCTS

STEEL COLUMNS

ANCHOR BOLTS, STEEL PLATES & ROLLED SECTIONS STEEL HSS & W-BEAMS

ALL OTHER STEEL STRUCTURAL BOLTS OBC 9 3 1

- CSA G30 - OBC 9.23 - OBC 9.23.4.3.

- OBC 9.17. - CAN/CSA-G40 21

- CAN/CSA-G40.21M-350W - CAN/CSA-G40.21M-300W

- ASTM A325

KEYPLAN

FOOTINGS AND FOUNDATIONS

- ALL FOOTINGS AND FOUNDATIONS SHALL CONFORM TO OBC 9.15. UNLESS NOTED OTHERWISE (U.N.O.) ON THE STAMPED DRAWINGS.
- FOOTINGS TO BEAR ON SOUND SUB-GRADE SUITABLE FOR 75 kPa (1,500 psf) ALLOWABLE SOIL BEARING CAPACITY. THE CLIENT IS TO INFORM WEL IF THE REQUIRED BEARING CAPACITY
- CAINNOT BE ACHIEVED.
 FOUNDATION WALLS SUPPORTING DRAINED EARTH HAVE BEEN DESIGNED FOR THE LOADS
 PROVIDED IN 9.4.4.6.(1)(a). ENSURE PROVISIONS ARE MADE FOR APPROPRIATE DRAINAGE OF **GROUNDWATER**
- ENSURE ALL FOUNDATION WALLS ARE LATERALLY SUPPORTED PRIOR TO BACKFILLING.
- ALL REINFORCING STEEL SHALL CONFORM TO THE REQUIREMENTS OF CAN/CSA-G30. REINFORCING BARS SHALL BE DEFORMED HI-BOND HARD GRADE WITH MINIMUM YIELD STRENGTH OF Fy = 400MPa.
- FOR ALL CONCRETE EXPECTED TO BE EXPOSED TO CHLORIDES (DE-ICING CHEMICALS), IT IS RECOMMENDED TO USE MINIMUM 32 MPa C-1 CONCRETE. COORDINATE DESIGN w/ CONCRETE DESIGNER & SUBMIT DESIGN MIX FOR REVIEW

WOOD-FRAME CONSTRUCTION

- ALL WOOD-FRAME CONSTRUCTION SHALL CONFORM TO OBC 9.23. U.N.O. ON THE STAMPED DRAWINGS
- ALL STRUCTURAL COMPOSITE LUMBER (SCL) SHALL BE 2.0E WITH Fb=2950 OR BETTER. FASTEN MULTI-PLY SCL BEAMS AS PER MANUFACTURER'S SPECIFICATIONS. PROVIDE 3" MIN. BEARING
- ALL PRE-ENGINEERED SYSTEMS (I.E. ROOF TRUSSES, FLOOR JOISTS, ETC.) ARE TO BE DESIGNED AND SEALED BY A PROFESSIONAL ENGINEER OF ONTARIO. PROVIDE LAYOUTS AND STAMPED DRAWINGS TO WEL AND THE LOCAL BUILDING DIVISION.
- ENSURE THE EXTERIOR WALLS ARE BRACED AS PER OBC 9.23.10.2. TO PROVIDE LATERAL SUPPORT FOR THE BUILDING.
- PROVIDE SUFFICIENT LATERAL SUPPORT FOR THE TOP OF ALL DROPPED BEAMS AND LINTELS TO PREVENT LATERAL TORSIONAL BUCKLING
- AN EXAMPLE OF SUFFICIENT LATERAL SUPPORT IS (2) 3 1/4" NAILS PER JOIST FOR LEDGER STRIP TO WOOD BEAM CONNECTION (AS PER OBC TABLE 9.23.3.4.). ALL WOOD COLUMNS SHALL CONFORM TO OBC 9.17. U.N.O. PROVIDE A BUILT-UP WOOD STUD
- COLUMN EQUAL TO THE WIDTH OF BEAM/GIRDER TRUSS UNDER ALL BEAM/GIRDER TRUSSES MIN. U.N.O. CONTINUE ALL COLUMNS DOWN TO FOUNDATION OR FULL BEARING ON BEAMS, BLOCK SOLID IN JOIST SPACES, TYPICAL (TYP.)
- ALL LINTELS TO HAVE 1 JACK STUD, 1 KING STUD AT ENDS U.N.O. ALL WOOD SHALL BE NO. 2 SPRUCE OR BETTER.
- ALL GUARDS SHALL CONFORM TO OBC 9.8.8. AND SUPPLEMENTARY STANDARD SB-7 U.N.O.


ROOF AND CEILING FRAMING

- ALL ROOF AND CEILING FRAMING SHALL CONFORM TO OBC 9.23.13. U.N.O. ON THE STAMPED
- ALL ROOF RAFTERS/JOISTS AND CEILING JOISTS SHALL CONFORM TO THE SPANS SHOWN IN OBC PART 9 TABLES A-3 TO A-7.
- WHERE REQUIRED, PROVIDE INTERMEDIATE SUPPORT FOR ROOF RAFTERS/JOISTS AS PER
- WEL ASSUMES THAT COLLAR TIES WILL BE USED TO PROVIDE INTERMEDIATE SUPPORT INSTEAD OF STRUTS OR DWARF WALLS U.N.O. (I.E. ALL ROOF RAFTERS/JOISTS BEAR ON EXTERIOR WALLS ONLY AND INTERIOR WALLS SUPPORT CEILING JOISTS ONLY U.N.O.). WHERE THE RIDGE IS UNSUPPORTED, ROOF RAFTERS/JOISTS ARE TO BE TIED TO THE CEILING
- JOISTS (OR SOLID BLOCKING AT 3'-11" o.c. MAX.) AT THEIR BASE AND NAILED AS PER OBC TABLE 9.23.13.8. TO PREVENT OUTWARD MOVEMENT.
- OVER-FRAMED AREAS ARE TO BE SUPPORTED ON LOWER ROOF RAFTERS/JOISTS BY 2x4 STRUTS @ 24" EACH WAY MIN., TYPICAL U.N.O.. WOOD ROOF TRUSSES SHALL BE DESIGNED IN ACCORDANCE WITH OBC 9.23.13.11., OR PART 4
- IF THEIR SPAN EXCEEDS 40'-0" (AS PER OBC 9.23.1.1).
 - IF THE TRUSSES ARE DESIGNED IN ACCORDANCE WITH OBC PART 4, THE DESIGN OF UPLIFT ANCHORS SHALL BE PROVIDED BY THE TRUSS SUPPLIER ALONG WITH LAYOUTS AND STAMPED DRAWINGS.

STRUCTURAL STEEL

- ALL WELDING SHALL BE PERFORMED BY A CANADIAN WELDING BUREAU CERTIFIED WELDER AND CONFORM TO CSA STANDARD W59.
- PROVIDE SUFFICIENT LATERAL SUPPORT FOR STEEL BEAMS TO PREVENT LATERAL TORSIONAL BUCKLING. SUFFICIENT LATERAL SUPPORT EXAMPLES:
 - A. DROPPED STEEL BEAM AS PROVIDED IN OBC 9.23.4.3.(3) OR 2x6 TOP PLATE w/ 13mm (1/2") dia. THRU BOLTS c/w NUTS & WASHERS OR HILTI X-U FASTENERS @ 600mm (24") o.c., STAGGERED INTO THE TOP FLANGE & (2) 3-1/4" TOE-NAILS FROM EACH FRAMING MEMBER
 - FLUSH STEEL BEAM SOLID BLOCKING (2x LUMBER AND PLYWOOD) BOLTED TO THE BEAM WEB WITH 13mm (1/2") dia. THRU BOLTS @ 600mm (24") o.c. (MAX, MATCH JOIST SPACING), STAGGERED TOP AND BOTTOM AND APPROVED FACE MOUNT HANGERS FOR THE FRAMING MEMBER TO BLOCKING CONNECTION.
- WHERE A STEEL BEAM SUPPORTS MASONRY, WELD 1/2" STEEL PLATE (WIDTH TO MATCH MASONRY) TO THE TOP OR BOTTOM FLANGE OF THE BEAM WITH (2) ROWS OF 50mm (2") LONG FILLET WELDS @ 300mm (12") o.c. MIN., STAGGERED.
- ALL STEEL BEAMS AND LINTELS SHALL HAVE MINIMUM 200mm (8") END BEARING ON MASONRY (TYPICAL U.N.O.). WELD BEAMS AND LINTELS TO BEARING PLATES, WHERE PROVIDED, WITH
- MINIMUM 4.8mm x 50mm (3/16" x 2") FILLET WELD EACH SIDE.
 ALL STEEL COLUMNS ARE TO BE LATERALLY SUPPORTED TOP & BOTTOM [I.E. BY CONCRETE SLAB ON GRADE, (2) 13mm (1/2") dia. BOLTS OR 50mm (2") OF 6.4mm (1/4") FILLET WELD MINIMUM]. CONTINUE ALL COLUMNS DOWN TO FOUNDATION OR FULL BEARING ON BEAMS, BLOCK SOLID
- ALL STRUCTURAL STEEL TO BE FINISHED AS APPROVED BY GENERAL CONTRACTOR.


VICTORIA RD S

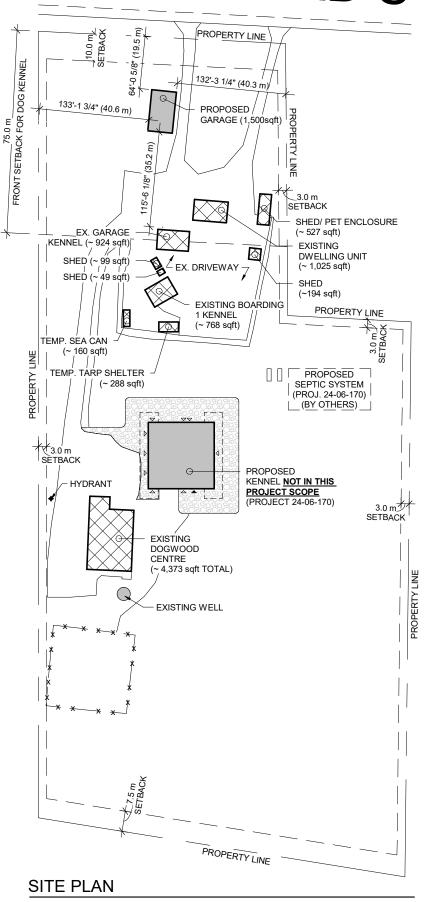

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STAMP:



WADDELL ENGINEERING LTD.

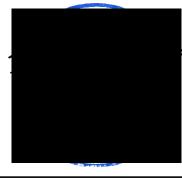119 PINEBUSH RD, UNIT C Phone: 519-267-6789 CAMBRIDGE, ON Fax: 1-866-388-9659 N1R 7.I8 www.waddelleng.com info@waddelleng.com PROJECT:

4424 VICTORIA RD S

30'x50' GARAGE 4424 VICTORIA RD S PUSLINCH, ON.


CLIENT: **FINE LINE STRUCTURES**


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GENERAL NOTES


DRAWN BY: WR DATE: DESIGN BY: AGRES SHEET NO SCALE: AS NOTED PROJECT NO: 25-02-051

2025/02/12




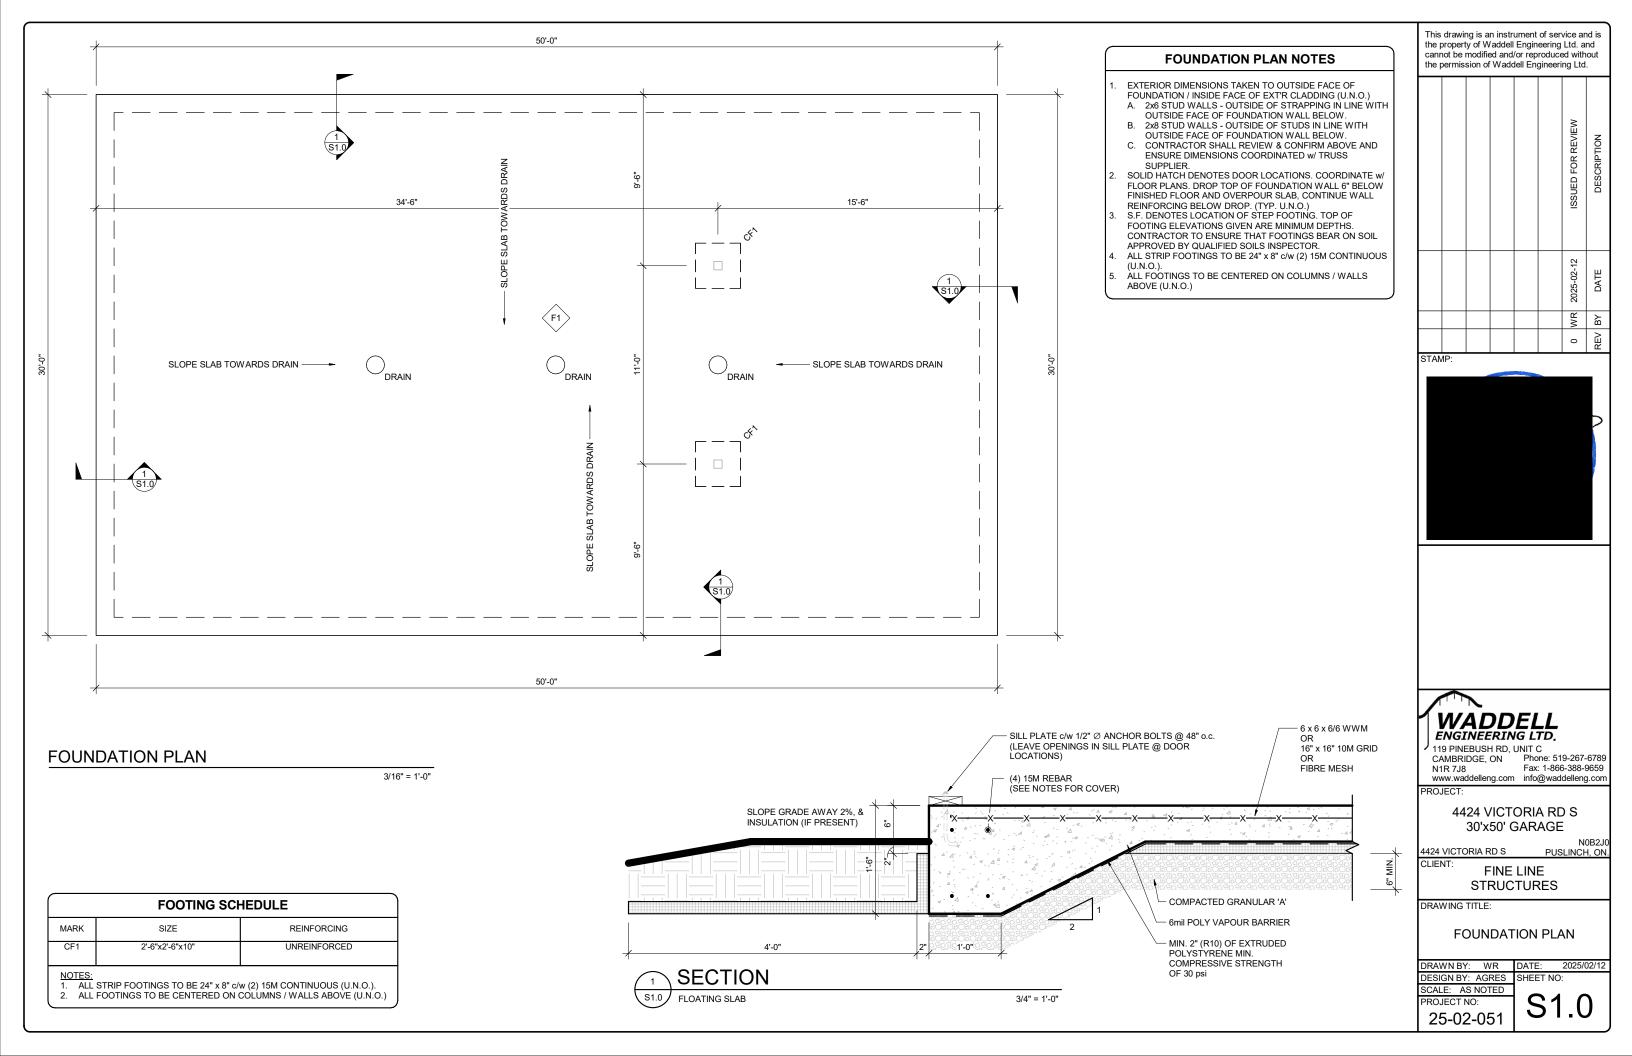
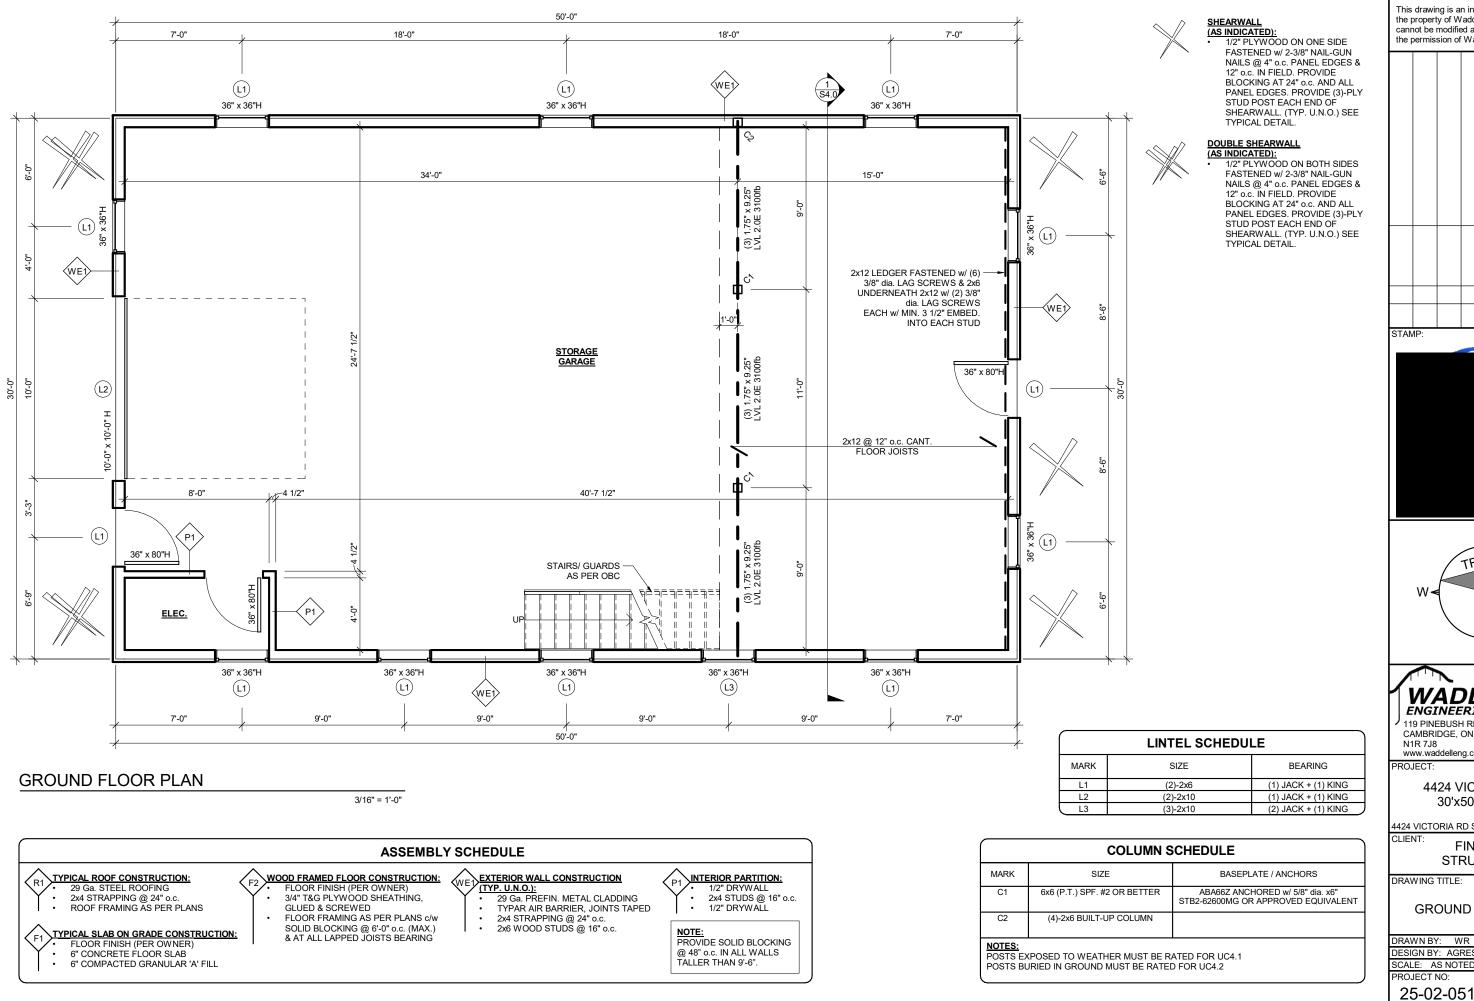
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4424 VICTORIA RD S

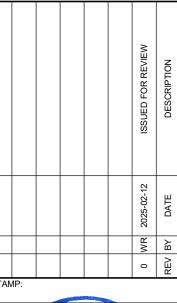30'x50' GARAGE


N0B2J0 4424 VICTORIA RD S PUSLINCH, ON.

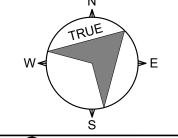
FINE LINE **STRUCTURES**


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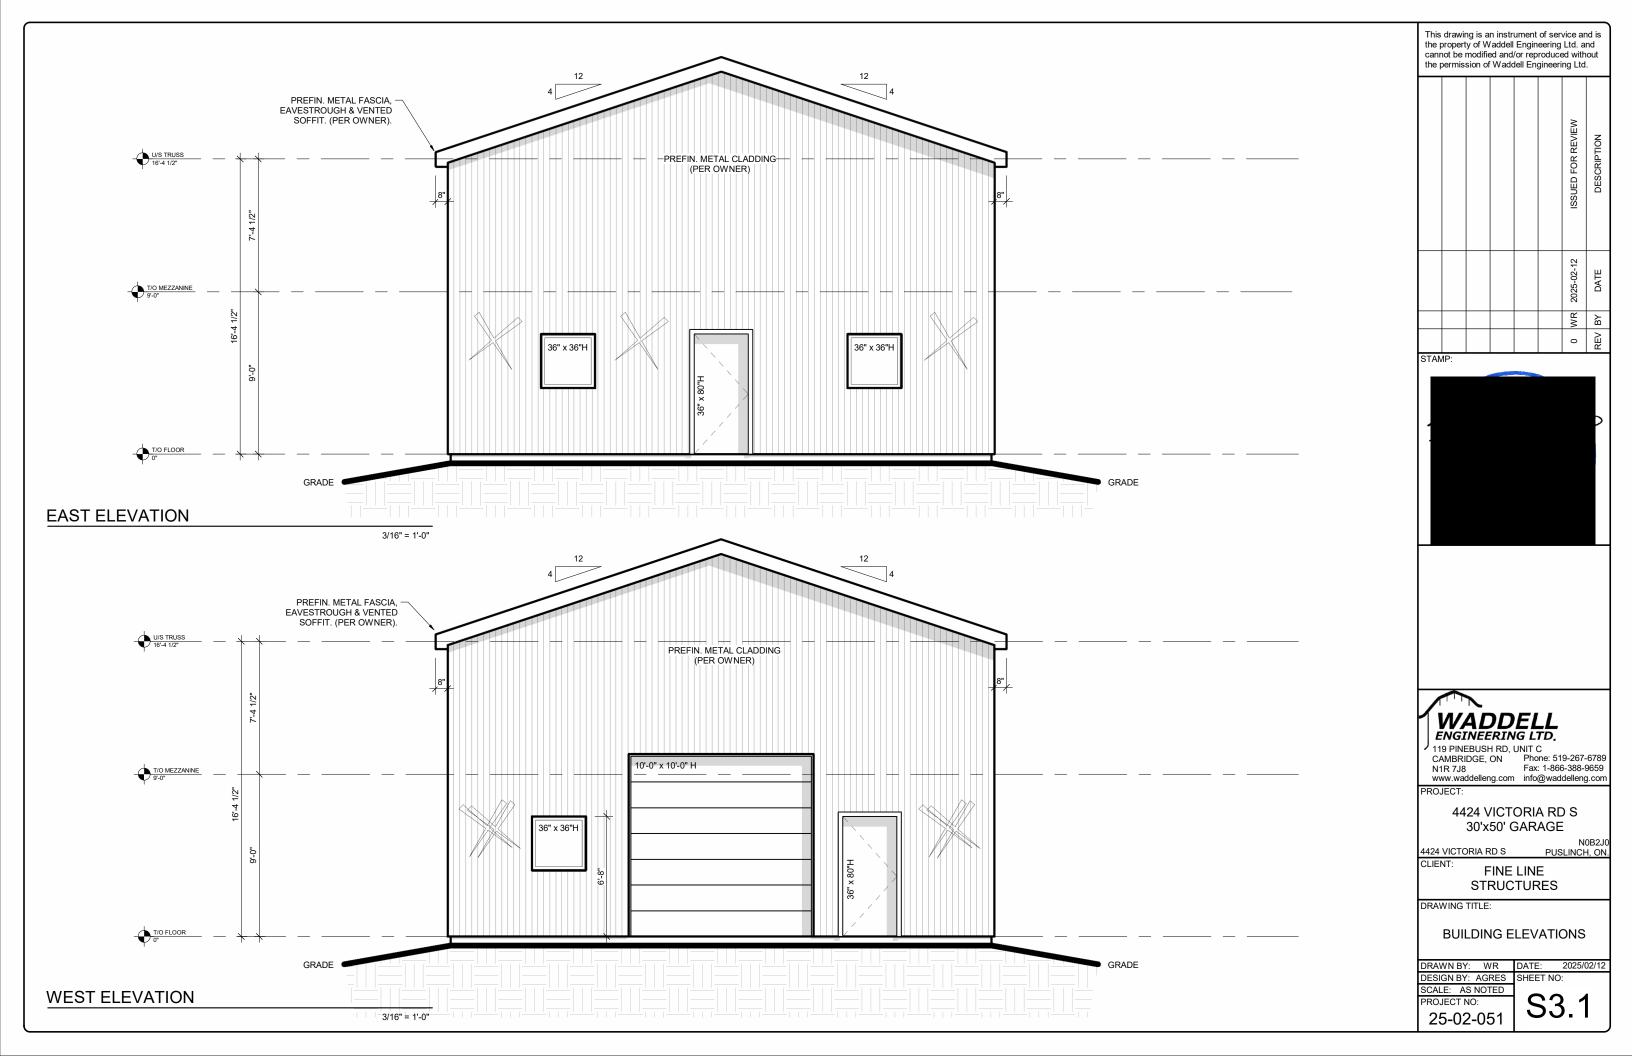
GROUND FLOOR PLAN


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DESIGN BY: AGRES	SHEET NO:
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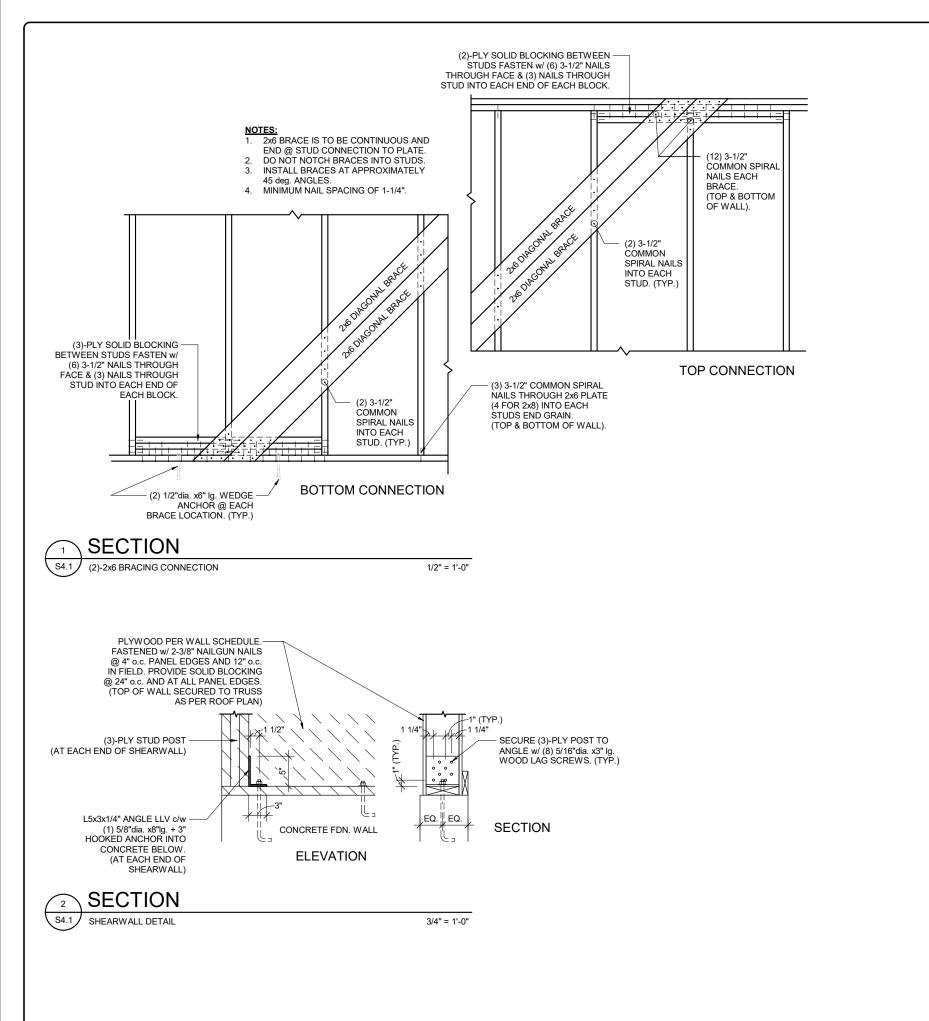




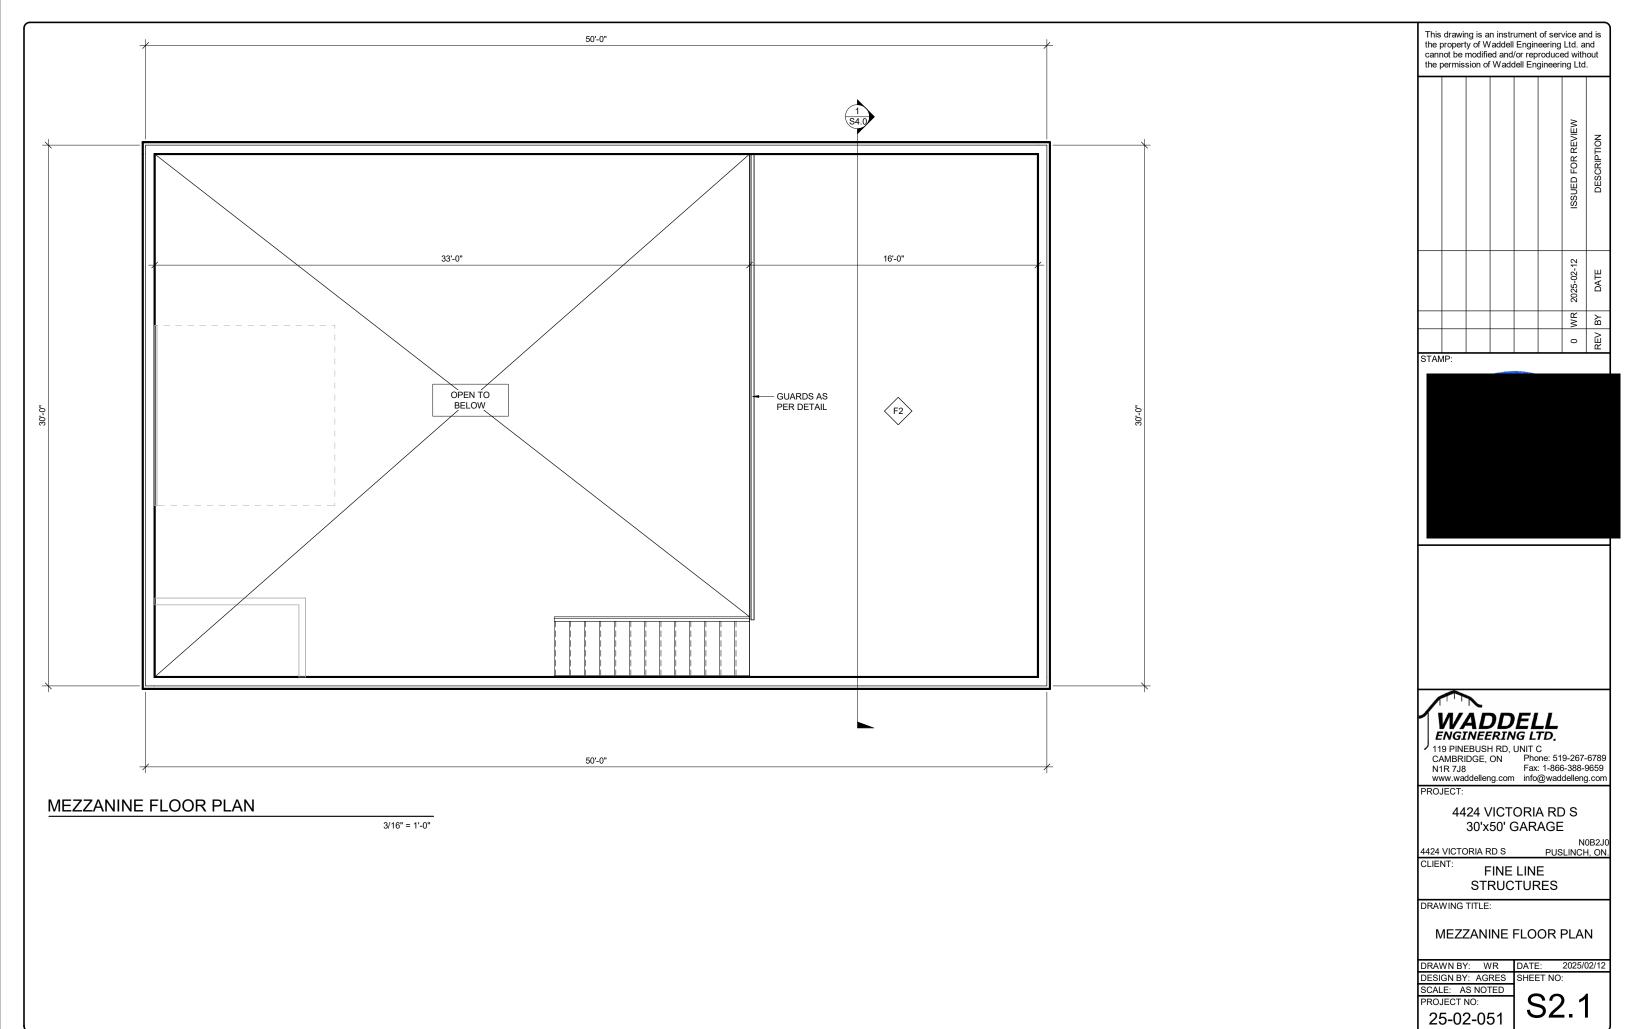


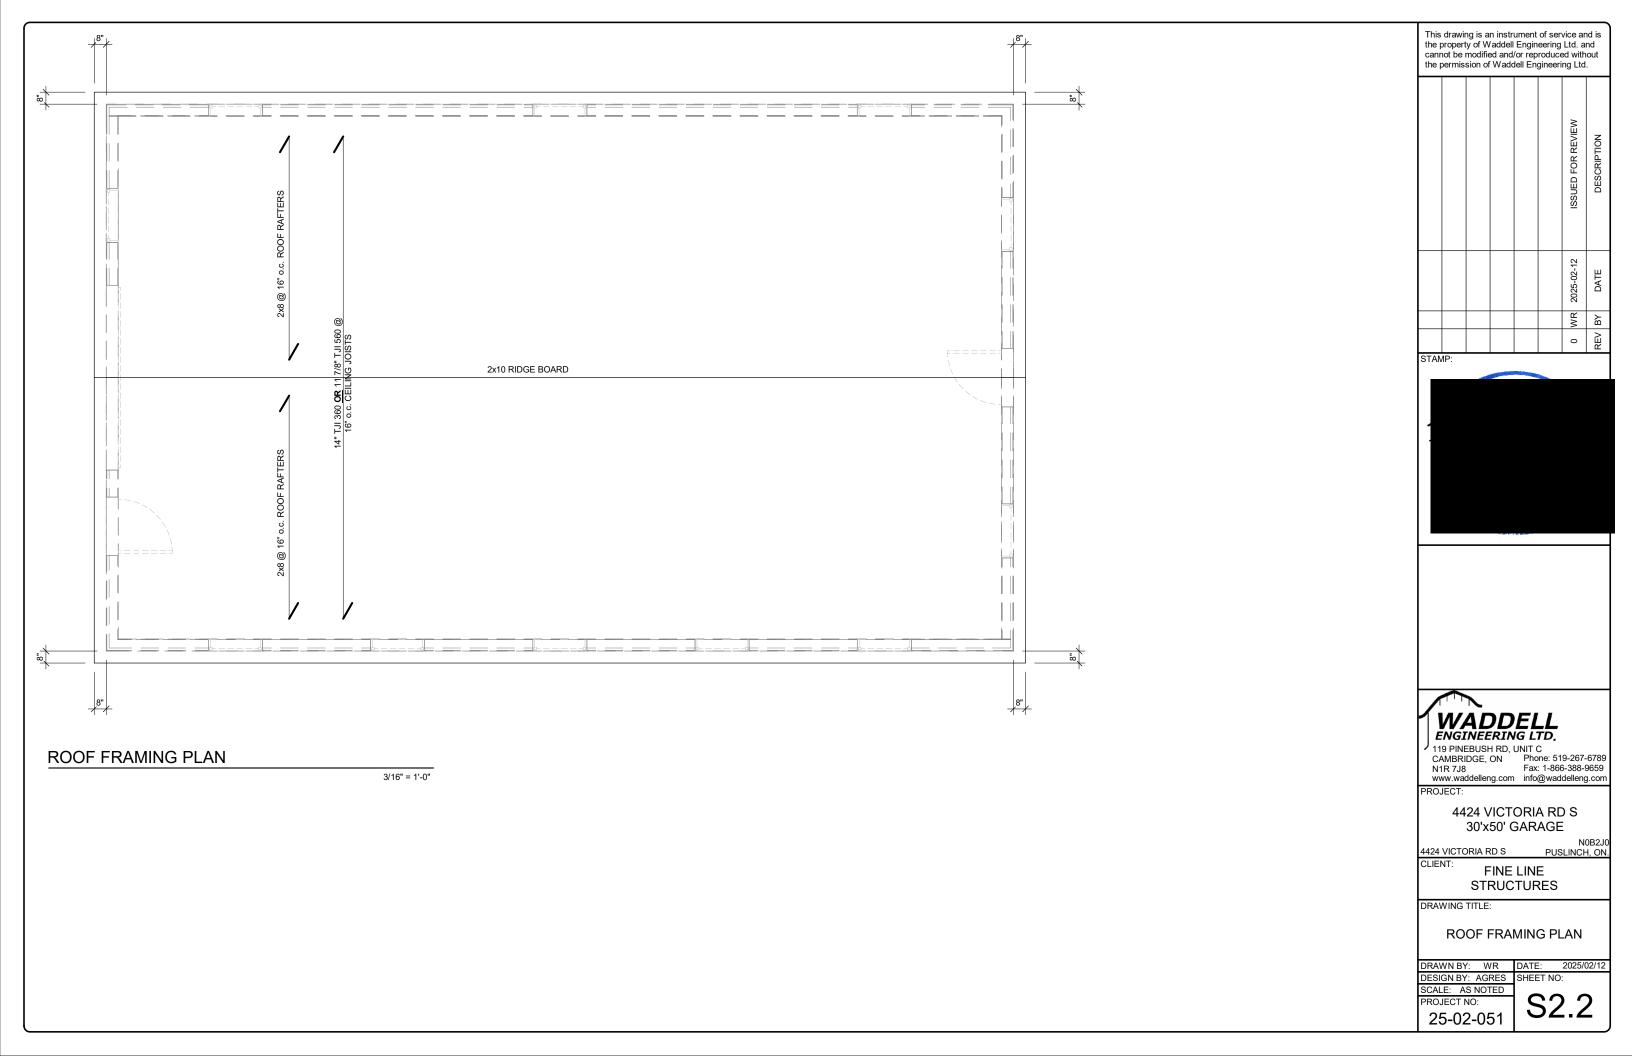

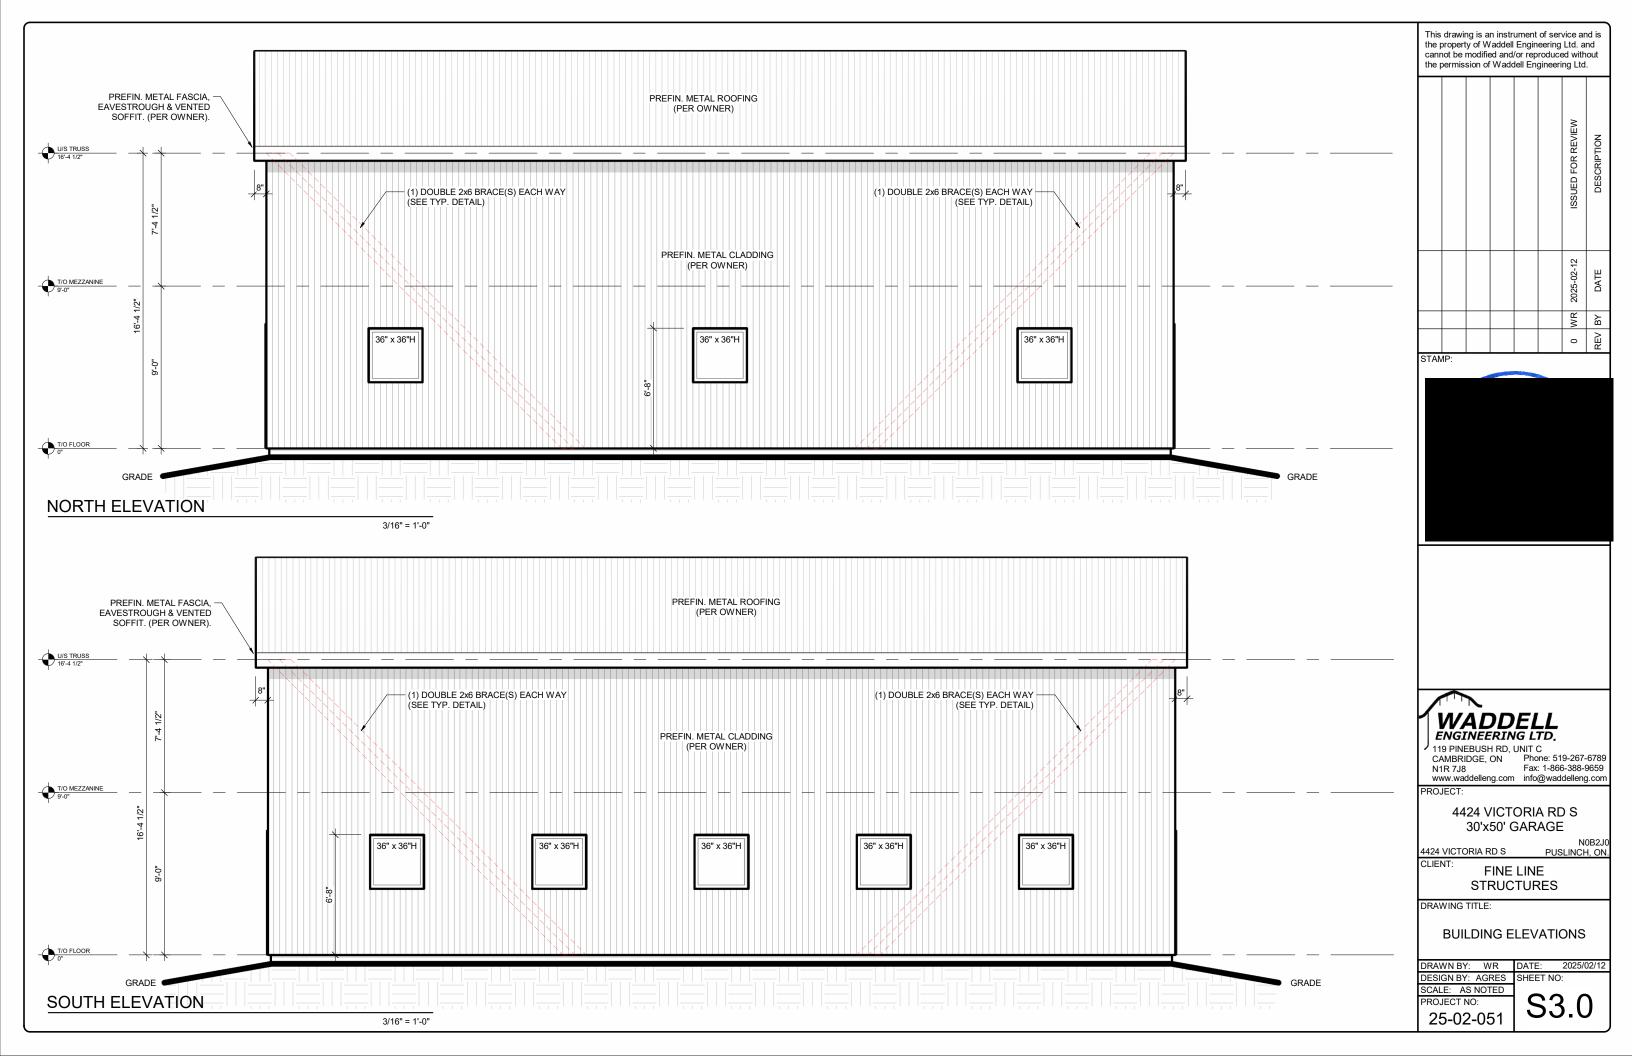


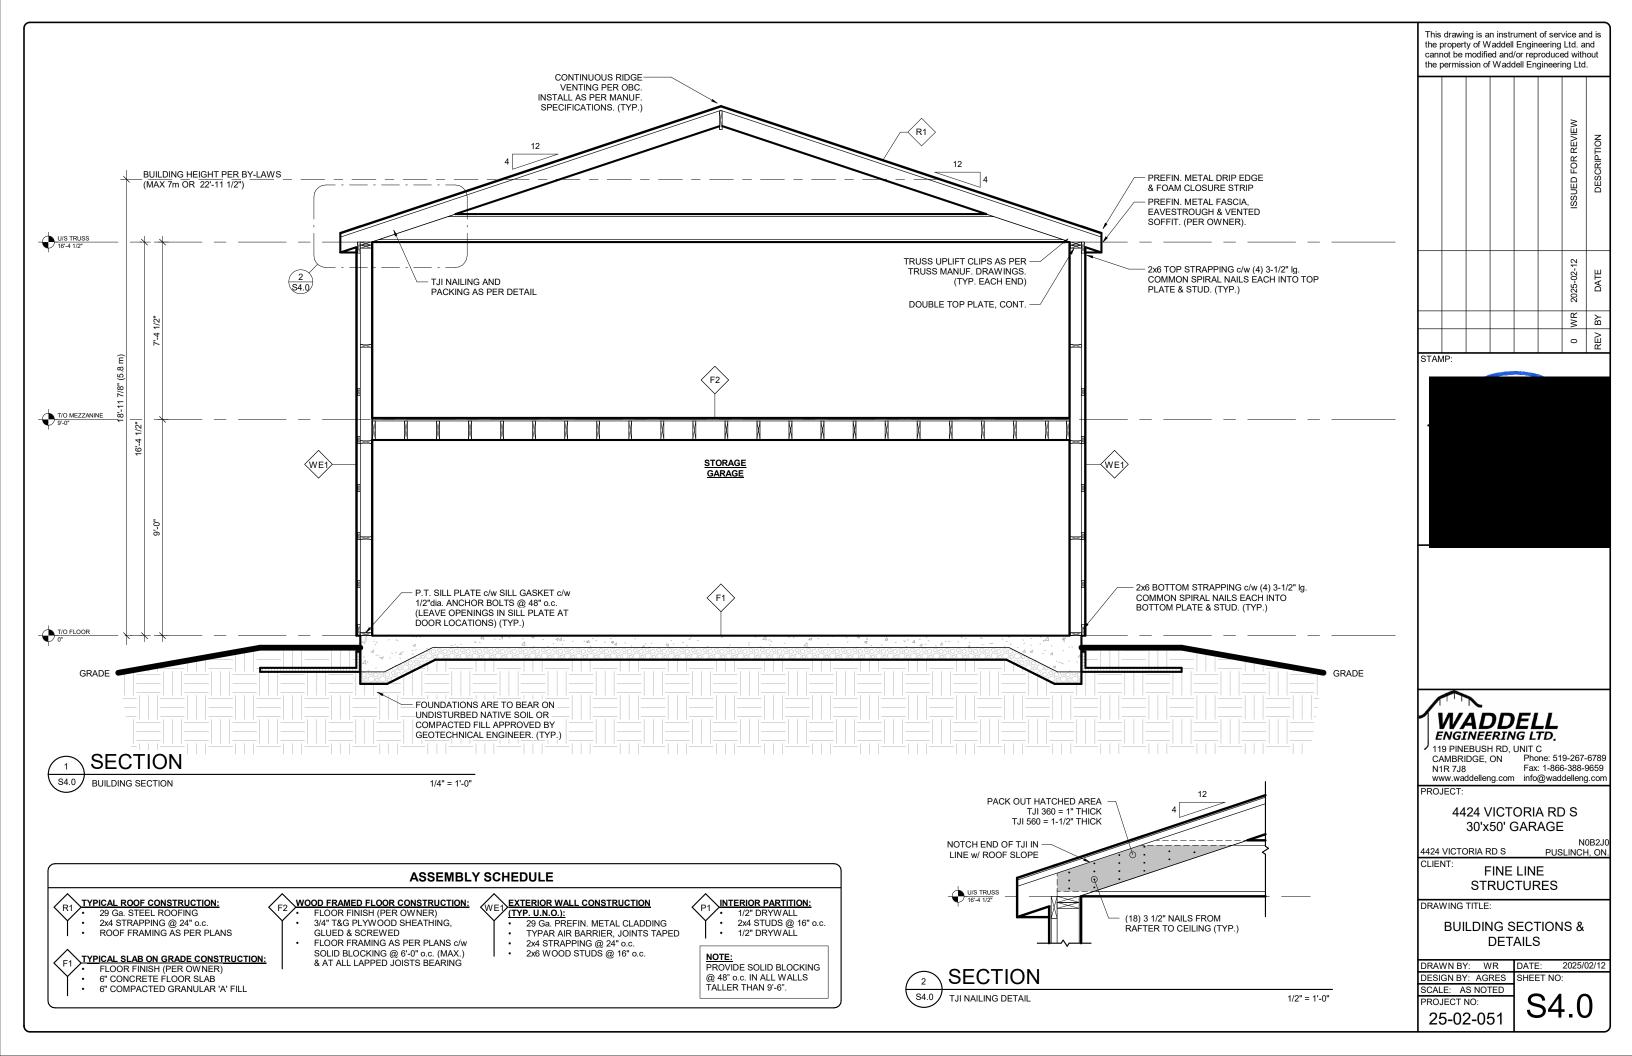

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PROJECT:

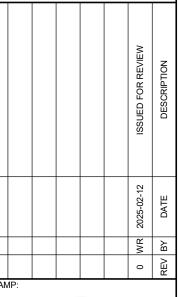4424 VICTORIA RD S 30'x50' GARAGE

4424 VICTORIA RD S PUSLINCH, ON.

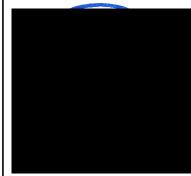CLIENT: FINE LINE **STRUCTURES**


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DETAILS

DRAWN BY: WR DATE: 2025/02/12 DESIGN BY: AGRES SHEET NO:

SCALE: AS NOTED PROJECT NO: 25-02-051


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			ISSUED FOR REVIEW	DESCRIPTION	
			0 WR 2025-02-12	DATE	
			WR	ВУ	
			0	REV BY	
IP:					

STAMP

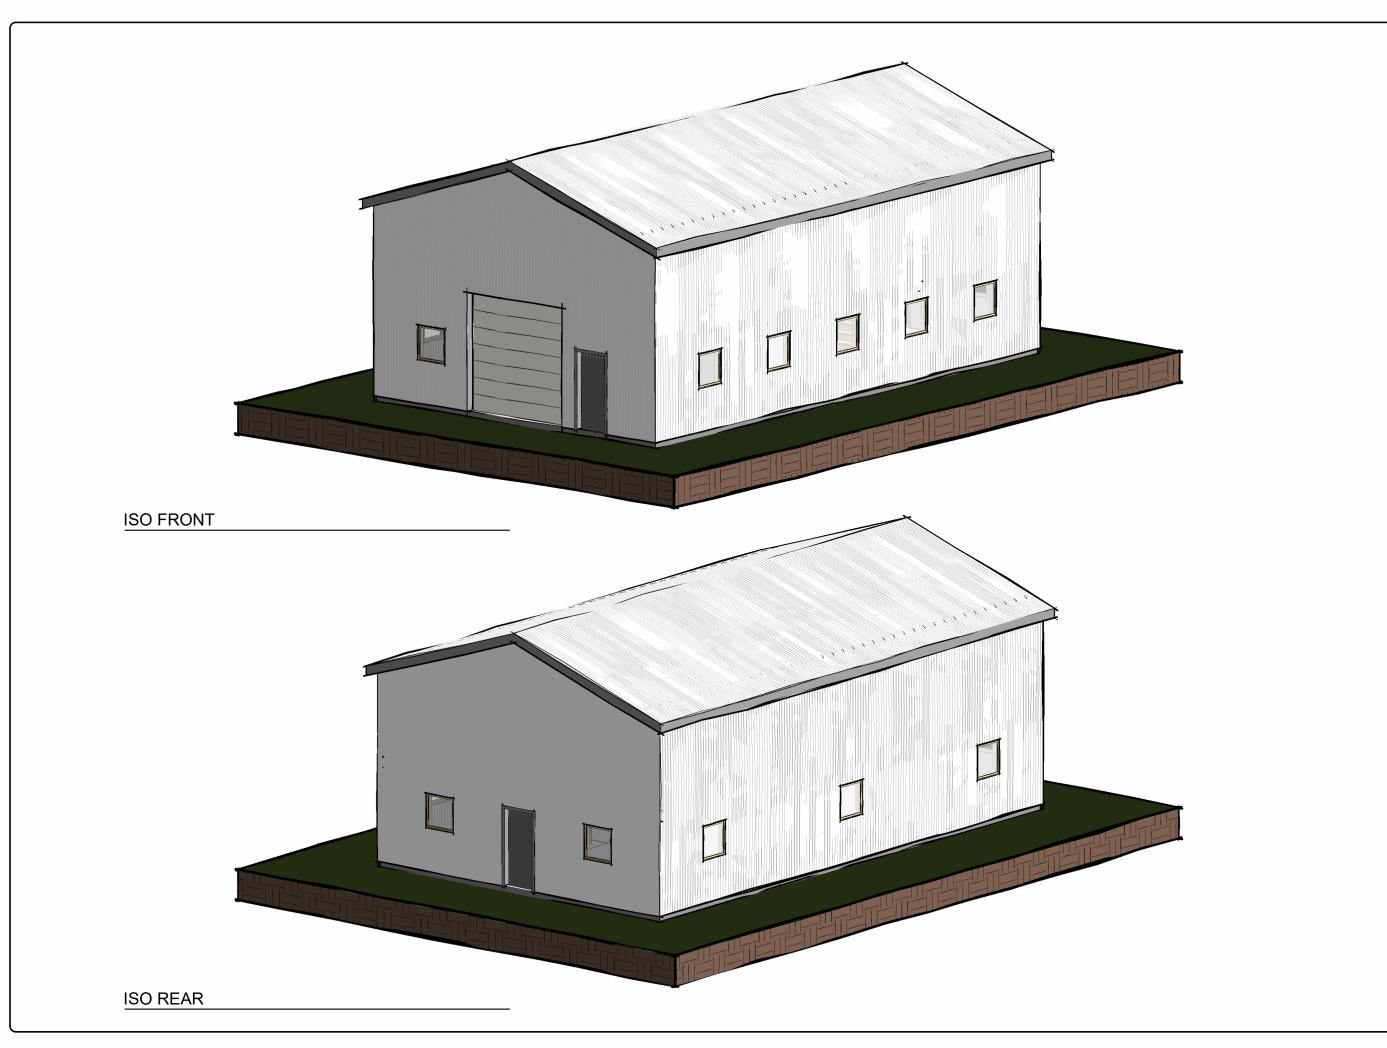

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PROJECT:

4424 VICTORIA RD S 30'x50' GARAGE

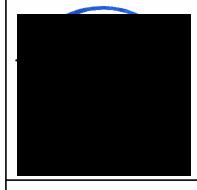N0B2J0 PUSLINCH, ON. 4424 VICTORIA RD S

CLIENT: FINE LINE STRUCTURES

DRAWING TITLE:

ISOMETRICS

DRAWN BY: WR DATE: 2025/02/12
DESIGN BY: AGRES SHEET NO:

SCALE: AS NOTED PROJECT NO: 25-02-051

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